

TOWN OF SEABROOK ISLAND

Public Works Committee Regular Meeting

April 3, 2023 – 12:00PM

Town Hall, Council Chambers
2001 Seabrook Island Road
Seabrook Island, SC 29455



[Watch Live Stream \(YouTube\)](#)

Virtual Participation: Individuals who wish to participate in the meeting via Zoom may call (843) 768-9121 or email kwatkins@townofseabrookisland.org for log-in information prior to the meeting.

AGENDA

CALL TO ORDER

Confirm meeting was posted and all requirements for the meeting are in accordance with SC Freedom of Information Act (FOIA).

APPROVAL OF MINUTES

1. Regular Meeting: Minutes from February 6th, 2023

OLD BUSINESS ITEMS

1. Review Revised Drawings for the proposed Town Hall Annex and Town Hall Garage
2. Review Proposed Crosswalk and Speed Limit Signage

NEW BUSINESS ITEMS

1. Open

ITEMS FOR INFORMATION / DISCUSSION

1. Open

ADJOURN

TOWN OF SEABROOK ISLAND

Public Works Committee

Regular Meeting

February 6, 2023 – Scheduled Time 12 PM



Held at Town Hall Council Chambers, Seabrook
2001 Seabrook Island Road Seabrook Island, SC 2945
Also available virtually - Hosted via Zoom
[Live Streamed on YouTube](#)

MINUTES

Members Present: Barry Goldstein
Ed Heskamp
Jeff Homeier
Glen Cox

Absent: Barry Hand

Others Present: Katharine Watkins, Town Clerk
Joe Cronin, Town Manager
Robert Meyer, Town Maintenance Manager

Chairman Barry Goldstein called the meeting to order at 12:01 PM. Chairman Goldstein confirmed with the Town of Seabrook Island Clerk that the requirements of the Freedom of Information Act were fulfilled, and the meeting agenda was properly posted.

APPROVAL OF MINUTES

1. **Regular Meeting: MEETING DATE 12/6/2022:** Committee members had no changes to the meeting minutes of 11/7/2022. Jeff Homeier made a motion to approve the minutes from the meeting of 11/7/2022. Ed Heskamp seconded the motion. The motion was **APPROVED** by a vote of 4 in favor to 0 opposed.

OLD BUSINESS ITEMS

1. Seabrook Island Garage and Town Hall Annex – The Town received the second-set of preliminary drawings for the Town Hall Annex and Garage. The drawings were forwarded to the PWC members for review.

Garage – Some of the noted updates to the garage included a secondary waterproof roof over the indoor storage area and the addition of a generator. Also, solar panels are not shown but will likely be located between the two dormers. Ed Heskamp noted that the Architect may

want to consider adding a door to the bathroom that is not inside the employee room to allow access from the vehicle maintenance area as well. No exterior bathrooms are included.

Electric Vehicle Charging Stations- will be located across from garage. Signage to be added for parking locations.

Public Space Between TH Annex and Garage – Design not updated. Will generally be nicely landscaped area with walkways to enter TH Annex. Examples such as the entrance to Sommerville TH were shown.

TH Annex – A food preparation area was added to the north side of the Council Chambers. Appliances will likely be limited to refrigerator and microwave. Rear area between new and old (“meditation garden”) will have the wood deck expanded.

Architects preliminary cost estimate for entire project came in about \$3,064,000. The cost estimate included about \$268,750 for renovations to old council chambers. It was discussed to postpone “most” of that work until the need, in the future, is identified. Some funds from this work likely to be reallocated to site work (public space/entrance). Additionally, some of the \$269k can be put towards garage solar and generator, which was not included in the estimate.

The cost estimate will be presented to the Town Council at the next TOSI Town Council meeting.

2. Design is proceeding and the timeline for a final set of drawings and full specification sufficient for the town to go out to bid is anticipated in spring.
3. It is anticipated that if the Town Council approves, the work would be let for construction in the spring of 2023 with construction to start thereafter,

NEW BUSINESS ITEMS

1. None

ITEMS FOR INFORMATION / DISCUSSION

There being no further business, the Chairman requested a motion to adjourn the meeting. Ed Heskamp made a motion to adjourn, and Glen Cox seconded the motion. The motion was **APPROVED** by a vote of 4 in FAVOR to 0 OPPOSED, and the meeting was adjourned.

205-00-00-05
HAULOVER CREEK
DEVELOPMENT
DB U296 PG 859
PB L08 PG 222

Seabrook Municipal Center Alterations

Town of Seabrook Island
2001 Seabrook Island Rd
Seabrook Island, SC

Revisions:




205-00-00-05
HAULOVER CREEK
DEVELOPMENT
DB U296 PG 859
PB L08 PG 222

147-00-00-02
THE CLUB AT
SEABROOK ISLAND
DB K204 PG 032
PB BD PG 164

PROPOSED SITE LAYOUT

MICHAEL E. KARAMUS
ARCHITECT, L.L.C.
P. O. Box 206
Johns Island, SC 29457

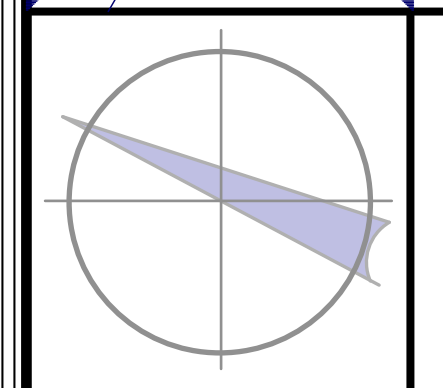

OWNERSHIP AND USE OF DOCUMENTS
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IN COLOR. CONTACT ARCHITECT FOR PROPER COLOR APPLICATION FOR PROJECT.

Scale:	1"=30'	Drawn:	MK	Checked:	MK
Date:	MARCH 23, 2023	Drawing No.:	L1.1		
Commission No.:	SC 2216A				

AB	ANCHOR BOLT	E	EAST	L	LEADER	REFR	REFRIGERATOR
ABV	ABOVE	EA	EACH	LAB	LABORATORY	REG	REGISTER
AC	AIR CONDITION	EB	EXPANSION BOLT	LAD	LADDER	REIN	REINFORCE(D)(ING)
ACC	ACCESS	EBP	EXPOSED BLOCK PAINTED	LAM	LAMINATED	REM	REMOVE
ACD	ACCESS DOOR	EG	ESTABLISHED GRADE	LAV	LAVATORY	RET	RETURN
ACL	ACCESS FLOOR	EJ	EXPANSION JOINT	LBL	LABEL	REV	REVISION
ACP	ACCESS PANEL	EL	ELEVATION	LCL	LINEN CLOSET	RL	RIGHT HAND
ACR	ACRYLIC PLASTIC	ELEC	ELECTRICAL	LEN	LENGTH	RH	RAIL(ING)
ACT	ACOUSTICAL TILE	ELEV	ELEVATOR	LH	LEFT HAND	RM	ROOM
ACT MAS	ACOUSTICAL MASONRY UNIT	EMER	EMERGENCY	LIN	LINOLEUM	RO	ROUGH OPENING
ADD	ADDENDUM	ENGL	EXPANDED METAL GUARD	LL	LIVE LOAD	ROW	RIGHT OF WAY
ADJ	ADJUSTABLE	ENCL	ENCLOSURE	LMS	LIMESTONE	S	SOUTH
ADJC	ADJACENT	ENT	ENTRANCE	LP	LOW POINT	SAC	SUSPENDED ACOUS CEILING
AF	ABOVE FINISH FLOOR	EP	ELECTRIC PANEL	LQ	LIGHT	SAD	SADDLE
AFG	ABOVE FINISH GRADE	EQ	EQUAL	LTL	LINTEL	SAE	SAME AS EXISTING
AGG	AGGREGATE	EQUIP	EQUIPMENT	LW	LIGHTWEIGHT	SAN	SANITATION
ALT	ALTERNATE	EST	ESTIMATE	LWC	LIGHTWEIGHT CONC	SCH	SOLID CORE
ALUM	ALUMINUM	EX	EXAMPLE	LWCB	LIGHTWEIGHT CONC BLOCK	SC	SCHEDULE
ANOD	ANODIZED	EXC	EXCAVATE	LVR	LOUVER	SCN	SCREEN
APD	APPROVED	MAD	METAL ACCESS DOOR	SCW	SOLID CORE WOOD		
APX	APPROXIMATE	EXIS	EXISTING	SD	STORM DRAIN		
ARCH	ARCHITECT(URAL)	EXP	EXPANSION	SEC	SECTION		
ASC	ABOVE SUSP CLG	EPSP	EXPOSED	MAT	MATERIAL		
ASPH	ASPHALT	EXT	EXTERIOR	MAX	MAXIMUM		
ASSEM	ASSEMBLY	F	FIXED	MB	MASTER BATH		
AT	ASPHALT TILE	FA	FIRE ALARM	MBDRM	MASTER BEDROOM		
AUD	AUDITORIUM	FAS	FASTENER	MBR	MEMBER		
AUTO	AUTOMATIC	FBD	FIBERBOARD	MC	MEDICINE CABINET		
AUX	AUXILIARY	FBO	FURNISHED BY OTHERS	MCR	MEDICINE CABINET, RECESSED		
&	AND	FC	FIRE CODE (CORE)	MCH	MECHANIC(AL)		
∠	ANGLE	FBRK	FIRE BRICK	MED	MEDIUM		
@	AT	FCC	FLUSHED CONCRETE CURB	MEM	MEMBRANE		
BC	BRICK COURSE	FD	FLOOR DRAIN	MET	METAL		
BD	BOARD	FEC	FIRE EXTINGUISHER CABINET	MF	METAL FURRING		
BEL	BELOW	FER	FIRE EXTINGUISHER RECESS	MFD	METAL FLOOR DECKING		
BFE	BASE FLOOD ELEVATION	FF	FACTORY FINISH	MFG	MANUFACTURE(ER)(ING)		
BFF	BELOW FINISH FLOOR	FH	FIRE HYDRANT	MHC	MANTHOLE COVER		
BFG	BELOW FINISH GRADE	FIN	FINISH(ED)	MIN	MINIMUM		
BES	BRONZE EXPANSION SADDLE	FJT	FLUSH JOINT	MIR	MIRROR		
BET	BETWEEN	FLASH	FLASHING	MIS	METAL INSECT SCREEN		
BIT	BITUMINOUS	FLD	FLOOD	MISC	MISCELLANEOUS		
BL	BUILDING LINE	FLOR	FLOURESCENT	MID	MOULDING		
BLDG	BUILDING	FLR	FLOOR	MNT	MOUNT(ED)(ING)		
BLK	BLOCK	FLT	FLUSH THREAD	MO	MASONRY OPENING		
BLKG	BLOCKING	FMS	FLUSH MARBLE SADDLE	MOV	MOVABLE		
BM	BEAM	FND	FOUNDATION	MP	METAL PARTITION		
BDC	BOTTOM OF CURB	FOB	FACE OF BRICK	MRD	METAL ROOF DECKING		
BOT	BOTTOM	FOC	FACE OF CONCRETE	MS	METAL STRIP		
BOW	BOTTOM OF WALL	FOF	FACE OF FINISH	MTHR	METAL THRESHOLD		
BPL	BEARING PLATE	FOM	FACE OF MASONRY	MULL	MULLION		
BRG	BEARING	FOS	FACE OF STUD	N	NORTH		
BRK	BRICK	FP	FIRE PROOF(ING)	NAT	NATURAL		
BRZ	BRONZE	FPL	FIREPLACE	ND	NOMINAL DIAMETER		
BS	BOTH SIDES	FLT	FLOOR PLATE	NO	NOT IN CONTRACT		
BSM	BASEMENT	FR	FRAME(D)(ING)	NO	NUMBER		
BVL	BEVELED	FR GYP BD	FIRE RATED GYPSUM BOARD	NOM	NOMINAL		
CAB	CABINET	FS	FLOOR SINK	NR	NOISE REDUCTION		
CAF	CAFETERIA	FT	FOOT/FEET	NRC	NOISE REDUCTION COEFFICIENT		
CARP	CARPET	FTG	FOOTING	NTS	NOT TO SCALE		
CB	CATCH BASIN	FUT	FUTURE	OA	OVERALL		
CEM	CEMENT	FVS	FLUSH VINYL SADDLE	OAI	OUTSIDE AIR INTAKE		
CER	CERAMIC	GA	GUAGE	OC	ON CENTER		
CG	CORNER GUARD	GALV	GALVANIZED	OD	OUTSIDE DIAMETER		
CI	CAST IRON	GB	GLAZED BLOCK	OE	OWNER FURNISHED EQUIPMENT		
CIR	CIRCLE	GC	GENERAL CONTRACTOR	OFF	OFFICE		
CIRC	CIRCUMFERENCE	GCMU	GLAZED CMU	OFS	OVER FLOW SCUPPER		
CJ	CONTROL JOINT	GD	GRADE(ING)	OH	OVERHEAD		
CL	CENTER LINE	GBDM	GRADE BEAM	OP	OPENING		
CLG	CEILING	GDEL	GRADE ELEVATION	OPH	OPPOSITE HAND		
CLL	CONTRACT LIMIT LINE	GDEL	GRADE ELEVATION	OPP	OPPOSITE		
CLOS	CLOSET	GI	GALVANIZED IRON	OSB	ORIENTED STRAND BOARD		
CLR	CLEAR(ANCE)	GL	GLASS	PAR	PARALLEL		
CLS	CLOSURE	GL	GLASS FIBER	PAR	PARALLEL		
CMT	CERAMIC MOSAIC TILE	GR	GRILLE	PART	PARTITION		
CMU	CONC MASONRY UNIT	GRN	GRANITE	PB	PANIC BAR		
COL	COLUMN	GRND	GROUND	PBD	PARTICLE BOARD		
COMP	COMPOSITION	GT	GROUT	PCF	POUNDS PER CUBIC FOOT		
CON	CONNECTION	GV	GAS VALVE	PE	PORCELIN ENAMEL		
CONC	CONCRETE	GVP	GYP VERMICULITE PLASTER	PER	PERIMETER		
CONST	CONSTRUCTION	GWT	GLAZED WALL TILE	PERF	PERFORATE(D)		
CONT	CONTINUOUS	GYP BD	GYPSUM BOARD	PFB	PREFABRICATE(D)		
CONTR	CONTRACT(OR)	H	HIGH	PFG	PLATE GLASS		
COR	CORRIDOR	HB	HOSE BIB	PL	PLATE		
CORR	CORRUGATED	HB	HARDBOARD	PLAM	PLASTIC LAMINATE		
CPR	COPPER	HBD	HARDBOARD	PLAS	PLASTER		
CPS	COURSE(S)	HC	HOLLOW CORE	PLATF	PLATFORM		
CSMT	CASEMENT	HD	HEAVY DUTY	PLF	POUNDS PER LINEAR FOOT		
CST	CAST STONE	HDCP	HANDICAPPED	PLT	PLATE		
CMT	CERAMIC TILE	HDWR	HARDWARE	PLYWD	PLYWOOD		
CU, FT	CUBIC FEET	HDR	HEADER	PLUM	PLUMBING		
CU, YD	CUBIC YARD	HGT	HEIGHT	PNL	PANEL		
D	DRAIN	HM	HOLLOW METAL	PNT	PAINT(ED)		
DA	DOUBLE ACTING	HNR	HAND RAIL	PRT	PRESSURE TREATED		
DB	DISPLAY BOARD	HOR	HORIZONTAL	PSF	POUNDS PER SQUARE FOOT		
DBL	DOUBLE	HP	HIGH POINT	PSI	POUNDS PER SQUARE INCH		
DC	DUST CHUTE	HR	HOUR(LY)	PT	POINT		
DEP	DEPRESSED	HTG	HEATING	PTT	PRECAST TERRAZZO TILE		
DEPT	DEPARTMENT	HVAC	HEATING VENT & AIR COND	PVC	POLYVINYL CHLORIDE		
DET	DETAIL	HWH	HOT WATER HEATER	PVM	PAVEMENT		
DF	DRINKING FOUNTAIN	ID	INSIDE DIAMETER	QT	QUARRY TILE		
DH	DOUBLE HUNG	INCL	INCLUDE (D)(ING)	R	RISER		
DI	DIAMETER	INSL	INSULATION (D)(ION)	RAD	RADIUS		
DIAG	DIAGONAL	INT	INTERIOR	RAG	RETURN AIR GRILLE		
DIM	DIMENSION	INTM	INTERMEDIATE	RIB	RUBBER BASE		
DISP	DISPENSER	JT	JOINT	RBL	RUBBLE STONE		
DISP CAB	DISPLAY CABINET	JT	JOINT FILLER	RBT	RABBIT		
DL	DEAD LOAD	KP	KICKPLATE	RBTL	RUBBER TILE		
DN	DOWN	RCP	REINFORCED CONC PIPE	RCD	ROOF DRAIN		
DN	DOWN	KIT	KITCHEN	RD	ROOF DRAIN		
DP	DAMPING	KO	KNOCKOUT	REC	RECESS(ED)		
DPR	DAMP	JT	JOINT	REF	REFLECT(ED)(IVE)(OR)		
DR	DOOR						
DS	DOWNSPOUT						
DTL	DRAIN TILE						
DT	DETAIL						
DWG	DRAWING						

TABLE 504.3 ALLOWABLE BUILDING HEIGHT IN FEET ABOVE GRADE PLANE**

OCCUPANCY CLASSIFICATION	SEE FOOTNOTES	TYPE OF CONSTRUCTION												
		TYPE I			TYPE II			TYPE III			TYPE IV		TYPE V	
		A	B	A	B	A	B	A	B	HT	A	B		
A, B, E, F, M, S, U	NS	UL	160	65	55	65	55	65	55	65	50	40	60	60
H-1, H-2, H-3, H-5	S	UL	180	85	75	85	75	85	75	85	70	60	90	90
	S	UL	160	65	55	65	55	65	55	65	50	40	60	60
H-4	NS-1	UL	160	65	55	65	55	65	55	65	50	40	60	60
	S	UL	180	85	75	85	75	85	75	85	70	60	90	90
I-1 Condition 1, 1-3	NS-1	UL	160	65	55	65	55	65	55	65	50	40	60	60
	S	UL	180	85	75	85	75	85	75	85	70	60	90	90
I-1 Condition 2, 1-2	NS-1	UL	160	65	55	65	55	65	55	65	50	40	60	60
	S	UL	180	85	75	85	75	85	75	85	70	60	90	90
L-4	NS-1	UL	160	65	55	65	55	65	55	65	50	40	60	60
	S	UL	180	85	75	85	75	85	75	85	70	60	90	90
	S	UL	160	65	55	65	55	65	55	65	50	40	60	60
	S	UL	160	65	55	65	55	65	55	65	50	40	60	60
R	NS-1	UL	160	65	55	65	55	65	55	65	50	40	60	60
	S	UL	180	85	75	85	75	85	75	85	70	60	90	90
	S	UL	180	85	75	85	75	85	75	85	70	60	90	90

For SI: 1 foot = 304.8 mm.
 * NS = Unlimited; UL = Buildings not equipped throughout with an automatic sprinkler system; S = Buildings equipped throughout with an automatic sprinkler system installed in accordance with Section 903.2.1.1, 919R, 919D or 919E, or buildings equipped throughout with an automatic sprinkler system installed in accordance with Section 903.2.1.2.
 ** See Chapter 4 and 5 for specific exceptions to the allowable height in this chapter.
 *** See Section 903.2 for the minimum threshold for protection by an automatic sprinkler system for specific occupancies.
 1. New Group H occupancies are required to be protected by an automatic sprinkler system in accordance with Section 903.2.5.
 4. The NS value is only to be used in the evaluation of existing building height in accordance with the South Carolina Existing Building Code.
 e. New Group I-1 and I-3 occupancies are required to be protected by an automatic sprinkler system in accordance with Section 903.2.6. For new Group I-1 occupancies (Condition 1) and Occupancy 1 of Section 903.2.6.
 f. New and existing Group I-2 occupancies are required to be protected by an automatic sprinkler system in accordance with Section 903.2.6 and Section 1103.5 of the South Carolina Fire Code.
 g. For new Group I-2 occupancies, see Exemption 2 and 3 of Section 903.2.6.
 h. New Group R occupancies are required to be protected by an automatic sprinkler system in accordance with Section 903.2.8.

IBC TABLE 504.3

TABLE 604 ALLOWABLE NUMBER OF STORIES ABOVE GRADE PLANE**

OCCUPANCY CLASSIFICATION	SEE FOOTNOTES	TYPE OF CONSTRUCTION												
		TYPE I			TYPE II			TYPE III			TYPE IV		TYPE V	
		A	B	A	B	A	B	A	B	HT	A	B		
A-1	NS	UL	5	3	2	3	2	3	2	3	2	1	1	
	S	UL	6	4	3	4	3	4	3	4	3	2	1	
A-2	NS	UL	11	3	2	3	2	3	2	3	2	1	1	
	S	UL	12	4	3	4	3	4	3	4	3	2	1	
A-3	NS	UL	11	3	2	3	2	3	2	3	2	1	1	
	S	UL	12	4	3	4	3	4	3	4	3	2	1	
A-4	NS	UL	11	3	2	3	2	3	2	3	2	1	1	
	S	UL	12	4	3	4	3	4	3	4	3	2	1	
A-5	NS	UL	UL	UL	UL	UL	UL	UL	UL	UL	UL	UL	UL	
	S	UL	UL	UL	UL	UL	UL	UL	UL	UL	UL	UL	UL	
B	NS	UL	11	5	3	5	3	5	3	5	3	2	1	
	S	UL	12	6	4	6	4	6	4	6	4	3	2	
E	NS	UL	5	3	2	3	2	3	2	3	1	1	1	
	S	UL	6	4	3	4	3	4	3	4	2	2	1	
F-1	NS	UL	12	5	3	4	3	5	3	5	3	2	1	
	S	UL	11	5	3	4	3	5	3	5	3	2	1	
F-2	NS-1	UL	12	6	4	5	4	6	4	6	4	3	2	
	S	UL	12	6	4	5	4	6	4	6	4	3	2	
H-1	NS-1	UL	1	1	1	1	1	1	1	1	1	1	NP	
	S	UL	3	2	1	2	1	2	1	2	1	1	1	
H-2	NS-1	UL	3	2	1	2	1	2	1	2	1	1	1	
	S	UL	6	4	2	4	2	4	2	4	2	1	1	
H-3	NS-1	UL	7	5	3	5	3	5	3	5	3	2	1	
	S	UL	8	6	4	6	4	6	4	6	4	3	2	
H-4	NS-1	UL	7	5	3	5	3	5	3	5	3	2	1	
	S	UL	8	6	4	6	4	6	4	6	4	3	2	
H-5	NS-1	UL	4	4	3	3	3	3	3	3	3	2	1	
	S	UL	9	4	3	4	3	4	3	4	3	2	1	
I-1 Condition 1	NS-1	UL	10	5	4	5	4	5	4	5	4	3	2	
	S	UL	10	5	4	5	4	5	4	5	4	3	2	
I-1 Condition 2	NS-1	UL	10	5	4	5	4	5	4	5	4	3	2	
	S	UL	10	5	4	5	4	5	4	5	4	3	2	
I-2	NS-1	UL	4	2	1	1								

Seabrook Municipal Center Alterations


Town of Seabrook Island
2001 Seabrook Island Rd
Seabrook Island, SC

Revisions:

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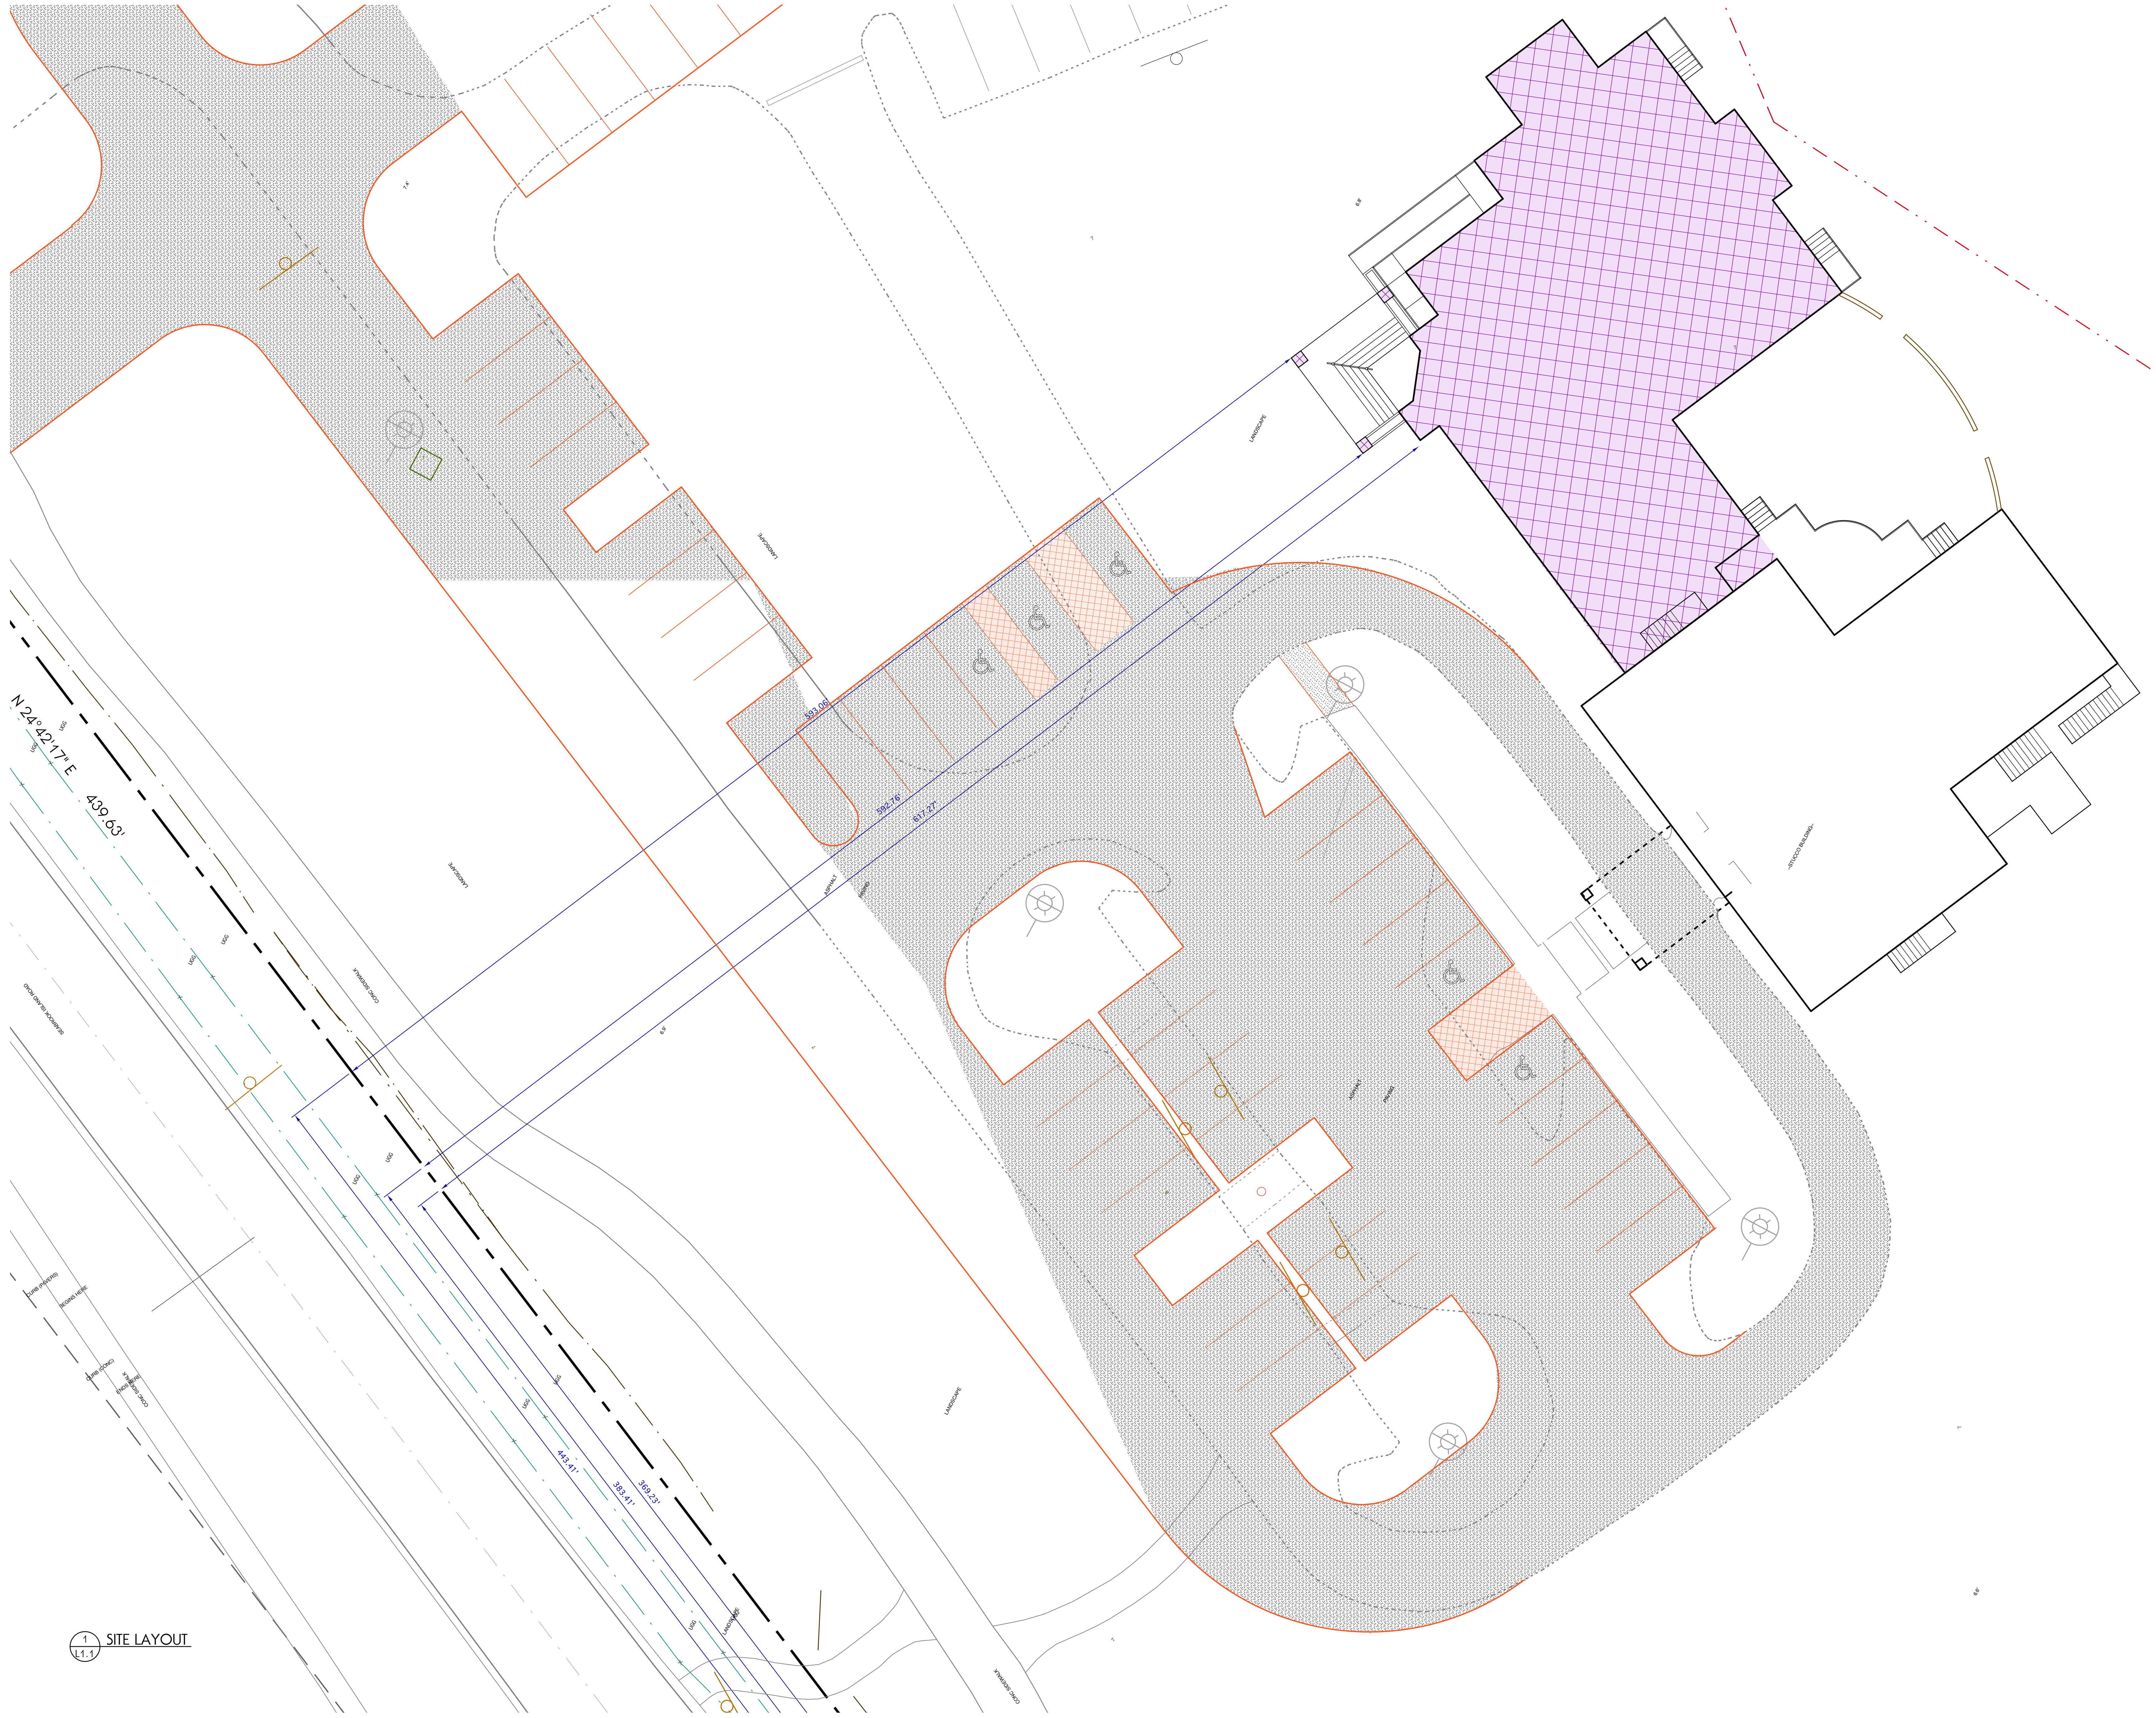
PROPOSED SITE LAYOUT

MICHAEL E. KARAMUS ARCHITECT, L.L.C.
P. O. Box 206
Johns Island, SC 29457

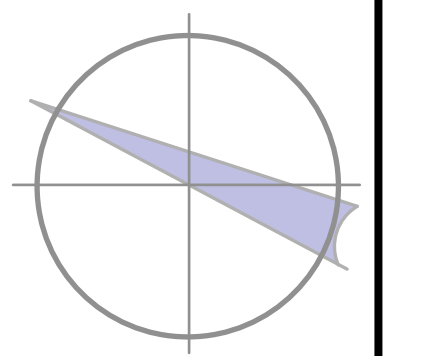

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Scale: 1"=10'	Drawn: MK	Checked: MK
Date: MARCH 23, 2023	Drawing No.: L1.1	
Commission No.: SC 2216A		




1 SITE LAYOUT
L1.1

Seabrook Municipal Center Alterations

Town of Seabrook Island
2001 Seabrook Island Rd
Seabrook Island, SC


Revisions:

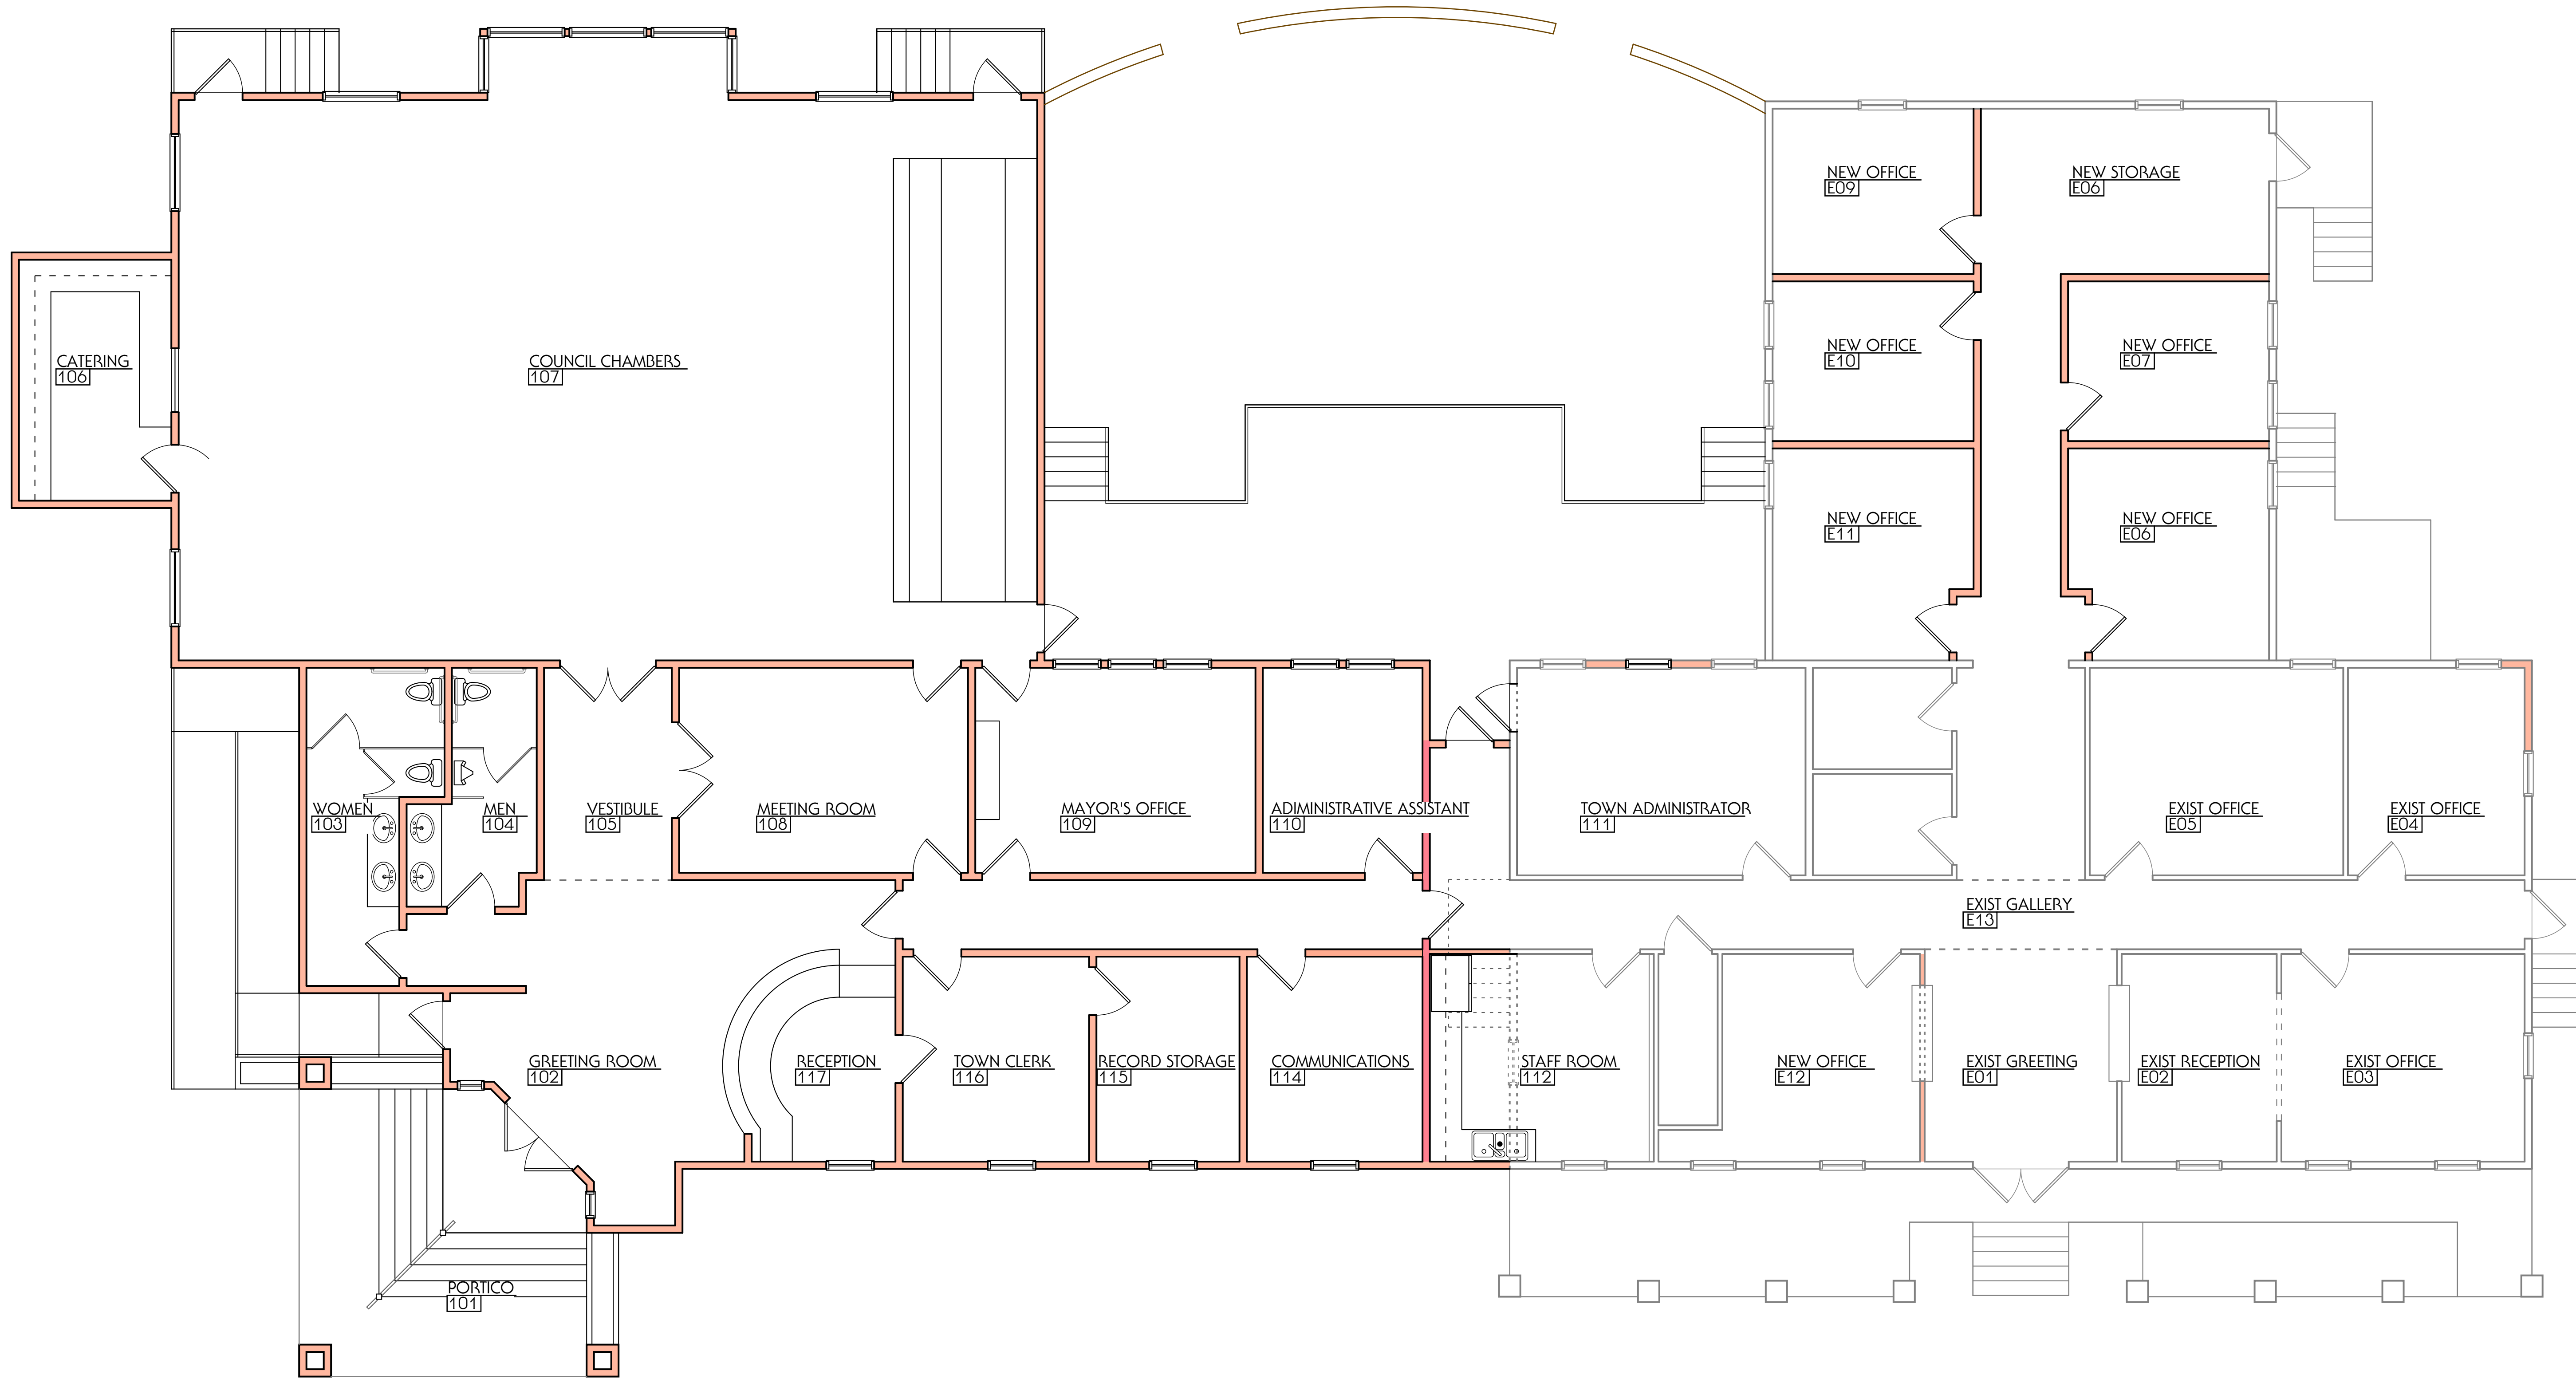

EXIST MUNICIPAL AREA: 3,157 S.F.
EXIST PORCH AREA: 512 S.F.
PROPOSED NEW MUNICIPAL AREA: 4,456 S.F.
PROPOSED NEW PORCH AREA: 324 S.F.
NEW DECK AREA: 596 S.F.

OVERALL MAIN FLOOR PLAN

MICHAEL E. KARAMUS
ARCHITECT, L.L.C.
P. O. Box 206
Johns Island, SC 29457

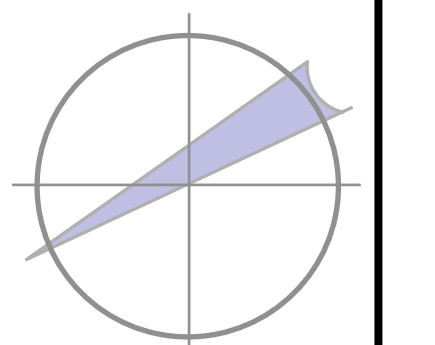

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Scale: 3/16"=1'-0" Drawn: MK Checked: MK

Date: MARCH 23, 2023 Drawing No.:


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A1.0

Seabrook Municipal Center Alterations

Town of Seabrook Island
2001 Seabrook Island Rd
Seabrook Island, SC


Revisions:

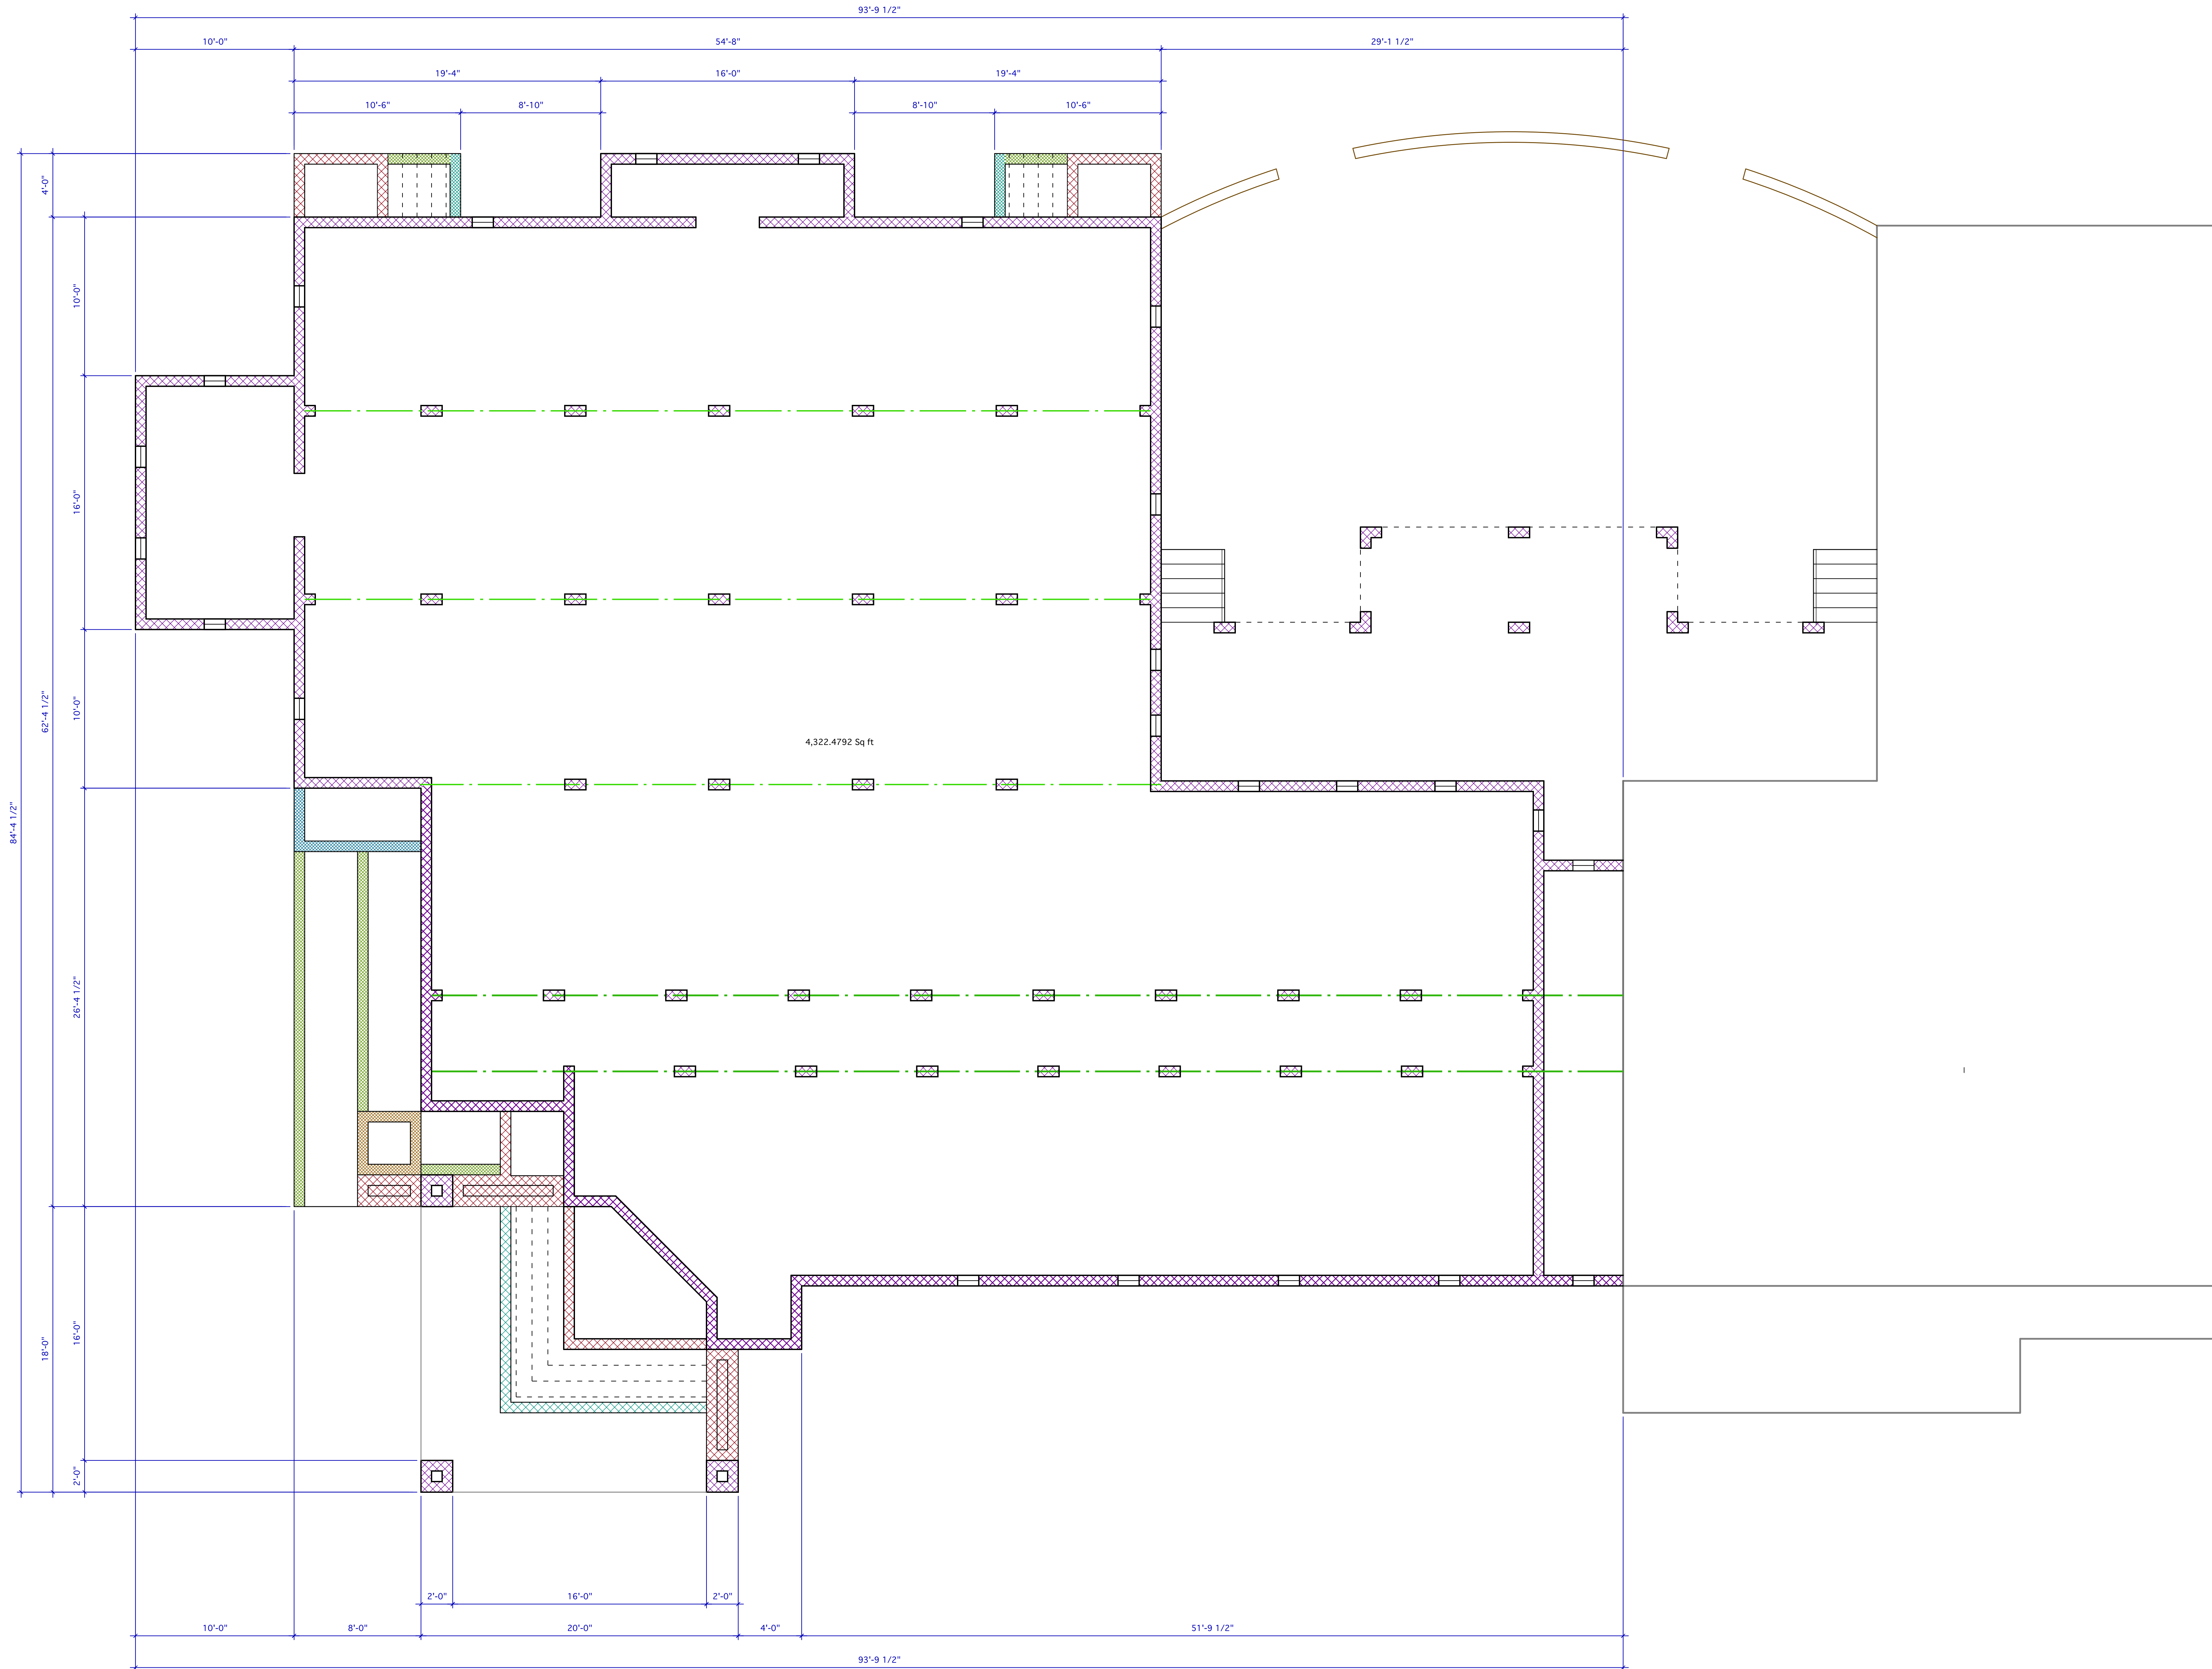

1 ANNEX FOUNDATION PLAN

ANNEX FOUNDATION PLAN

MICHAEL E. KARAMUS
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Date: MARCH 23, 2023 Drawing No.:

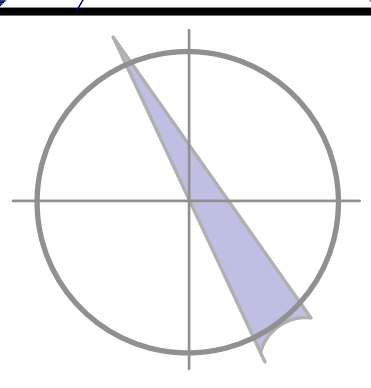
Commission No.: SC 2216A

A1.1

Seabrook Municipal Center Alterations


Town of Seabrook Island
2001 Seabrook Island Rd
Seabrook Island, SC

Revisions:

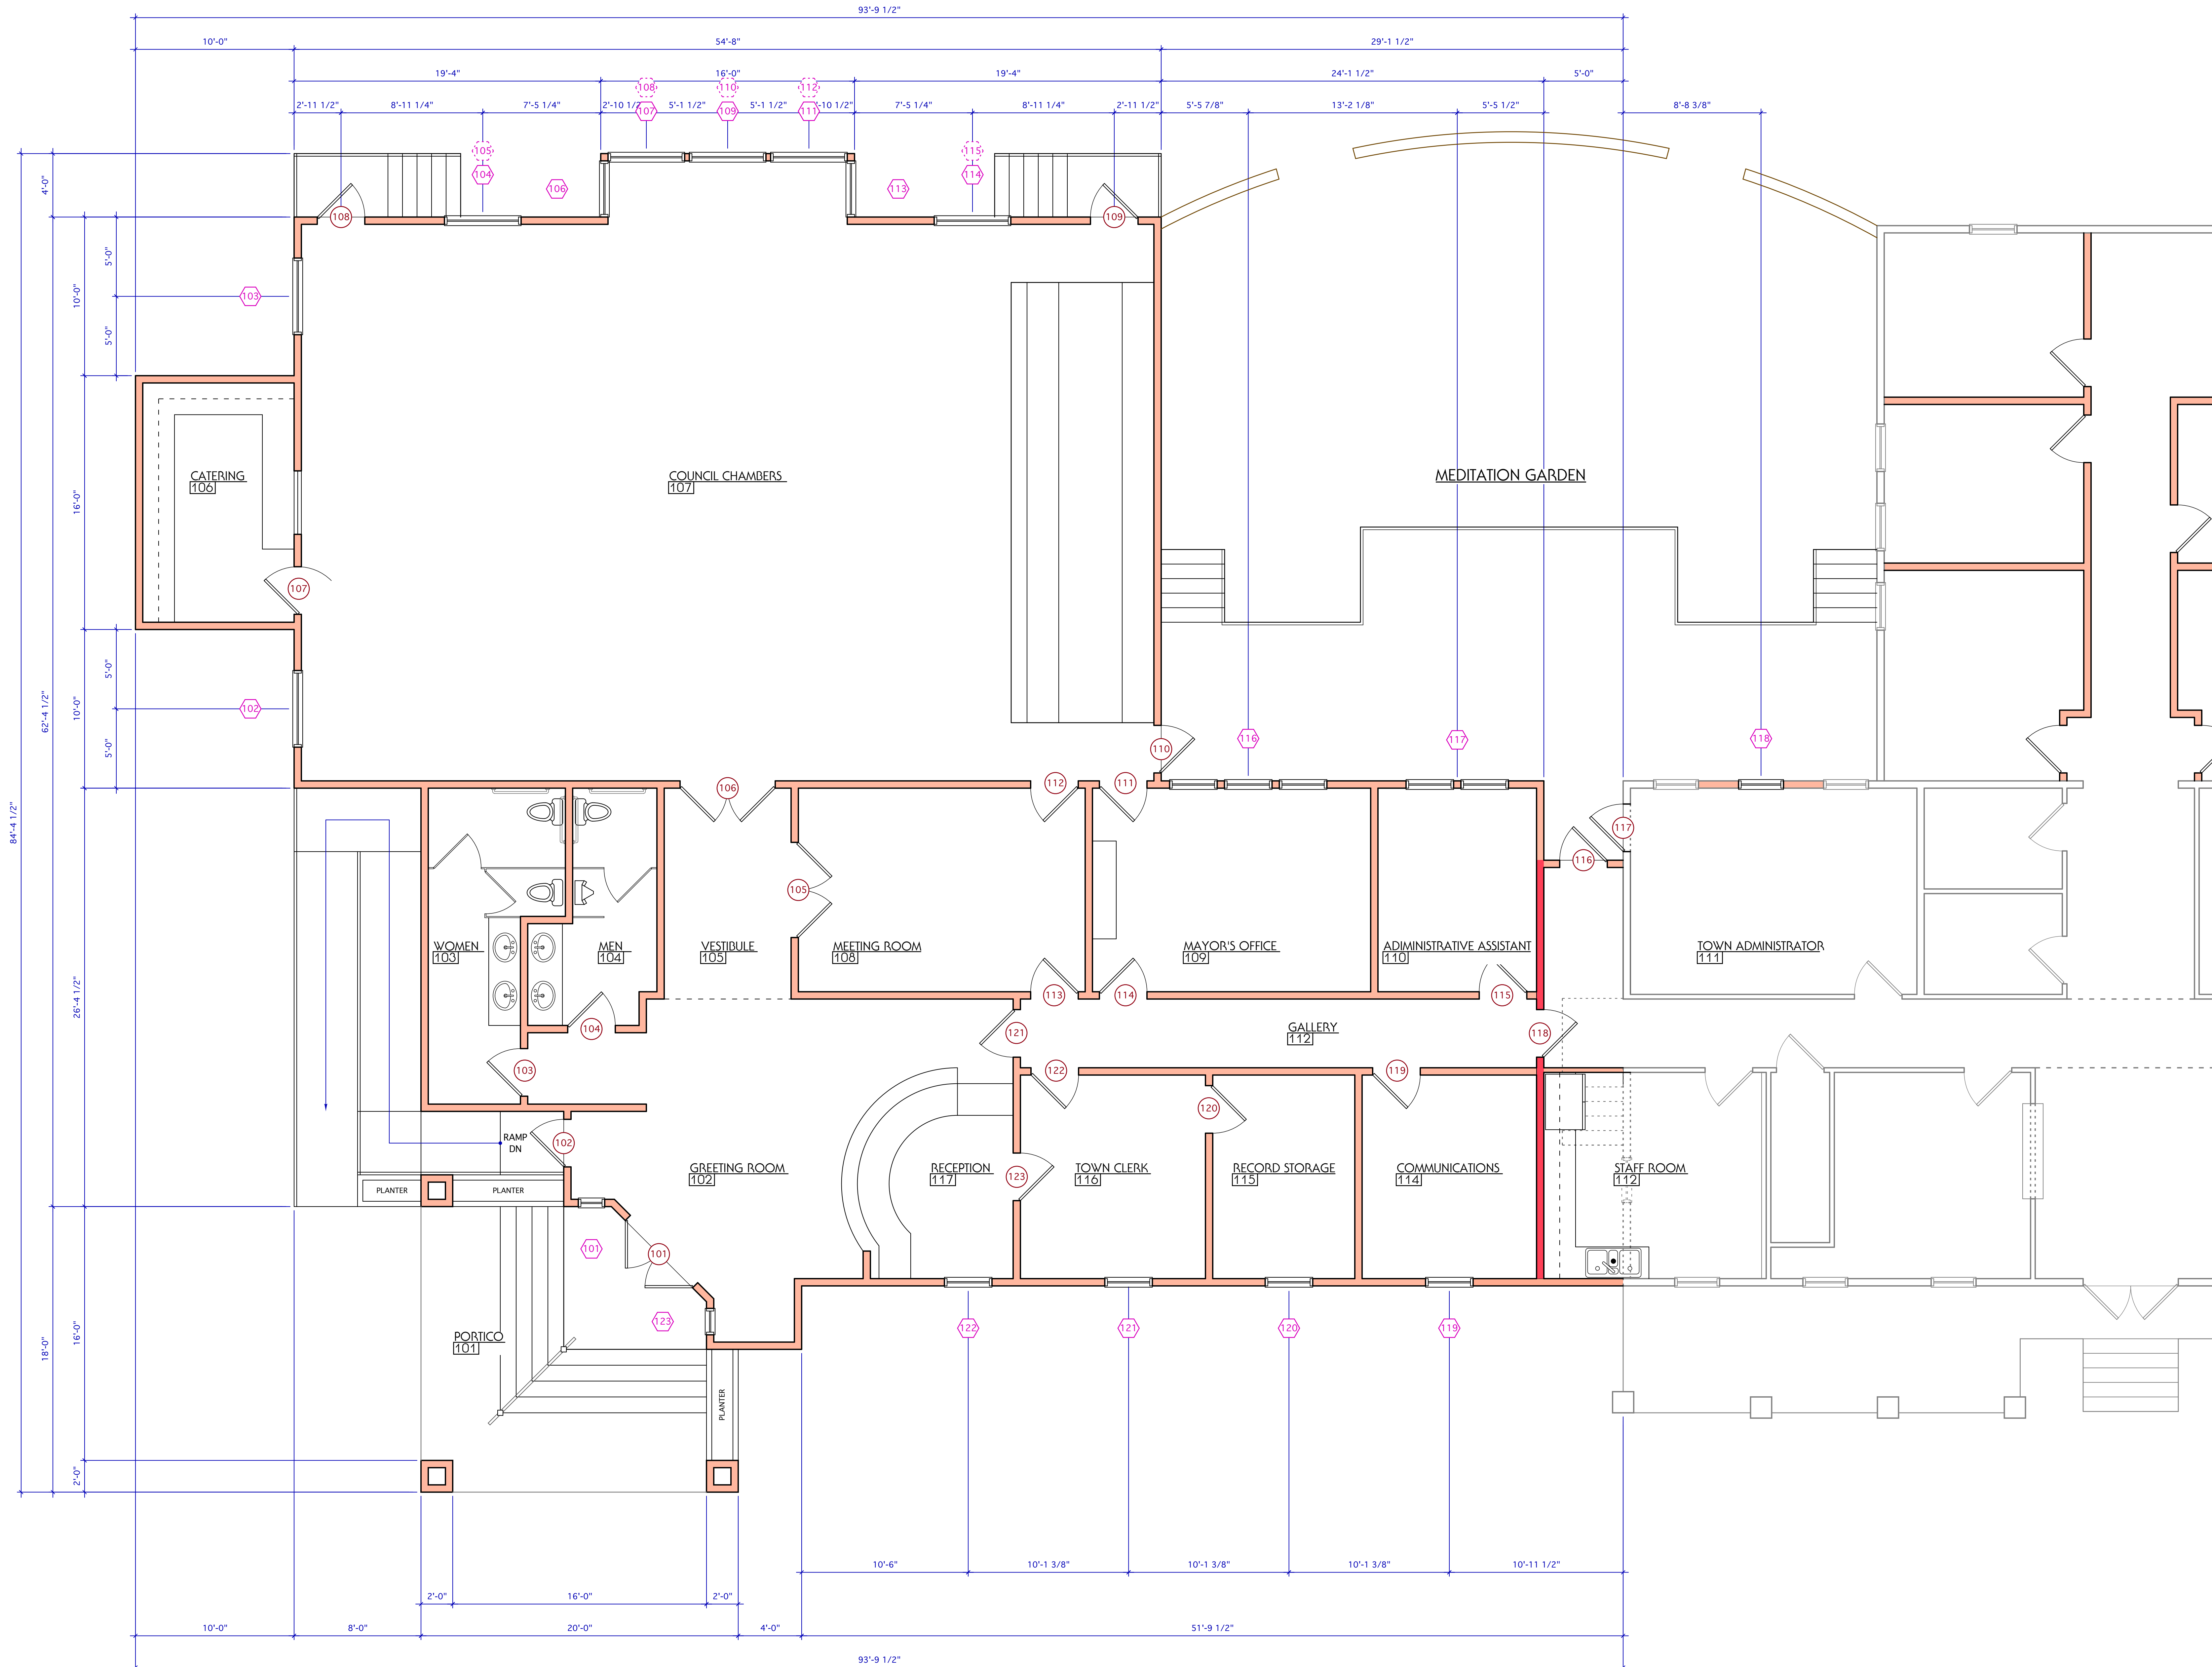

ANNEX MAIN FLOOR PLAN

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Scale: 1/4"=1'-0"	Drawn: MK	Checked: MK
Date: MARCH 23, 2023	Drawing No.:	
Commission No.:	A1.2	
SC 2216A		

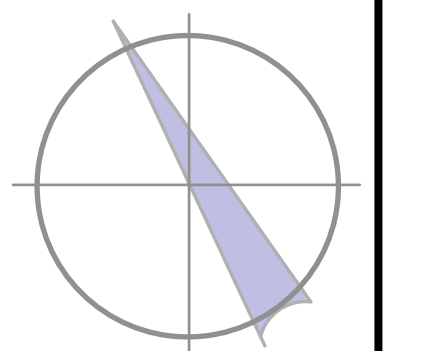
Seabrook Municipal Center Alterations

Town of Seabrook Island
2001 Seabrook Island Rd
Seabrook Island, SC

Revisions:

ANNEX ROOF PLAN

MICHAEL E. KARAMUS ARCHITECT, L.L.C.
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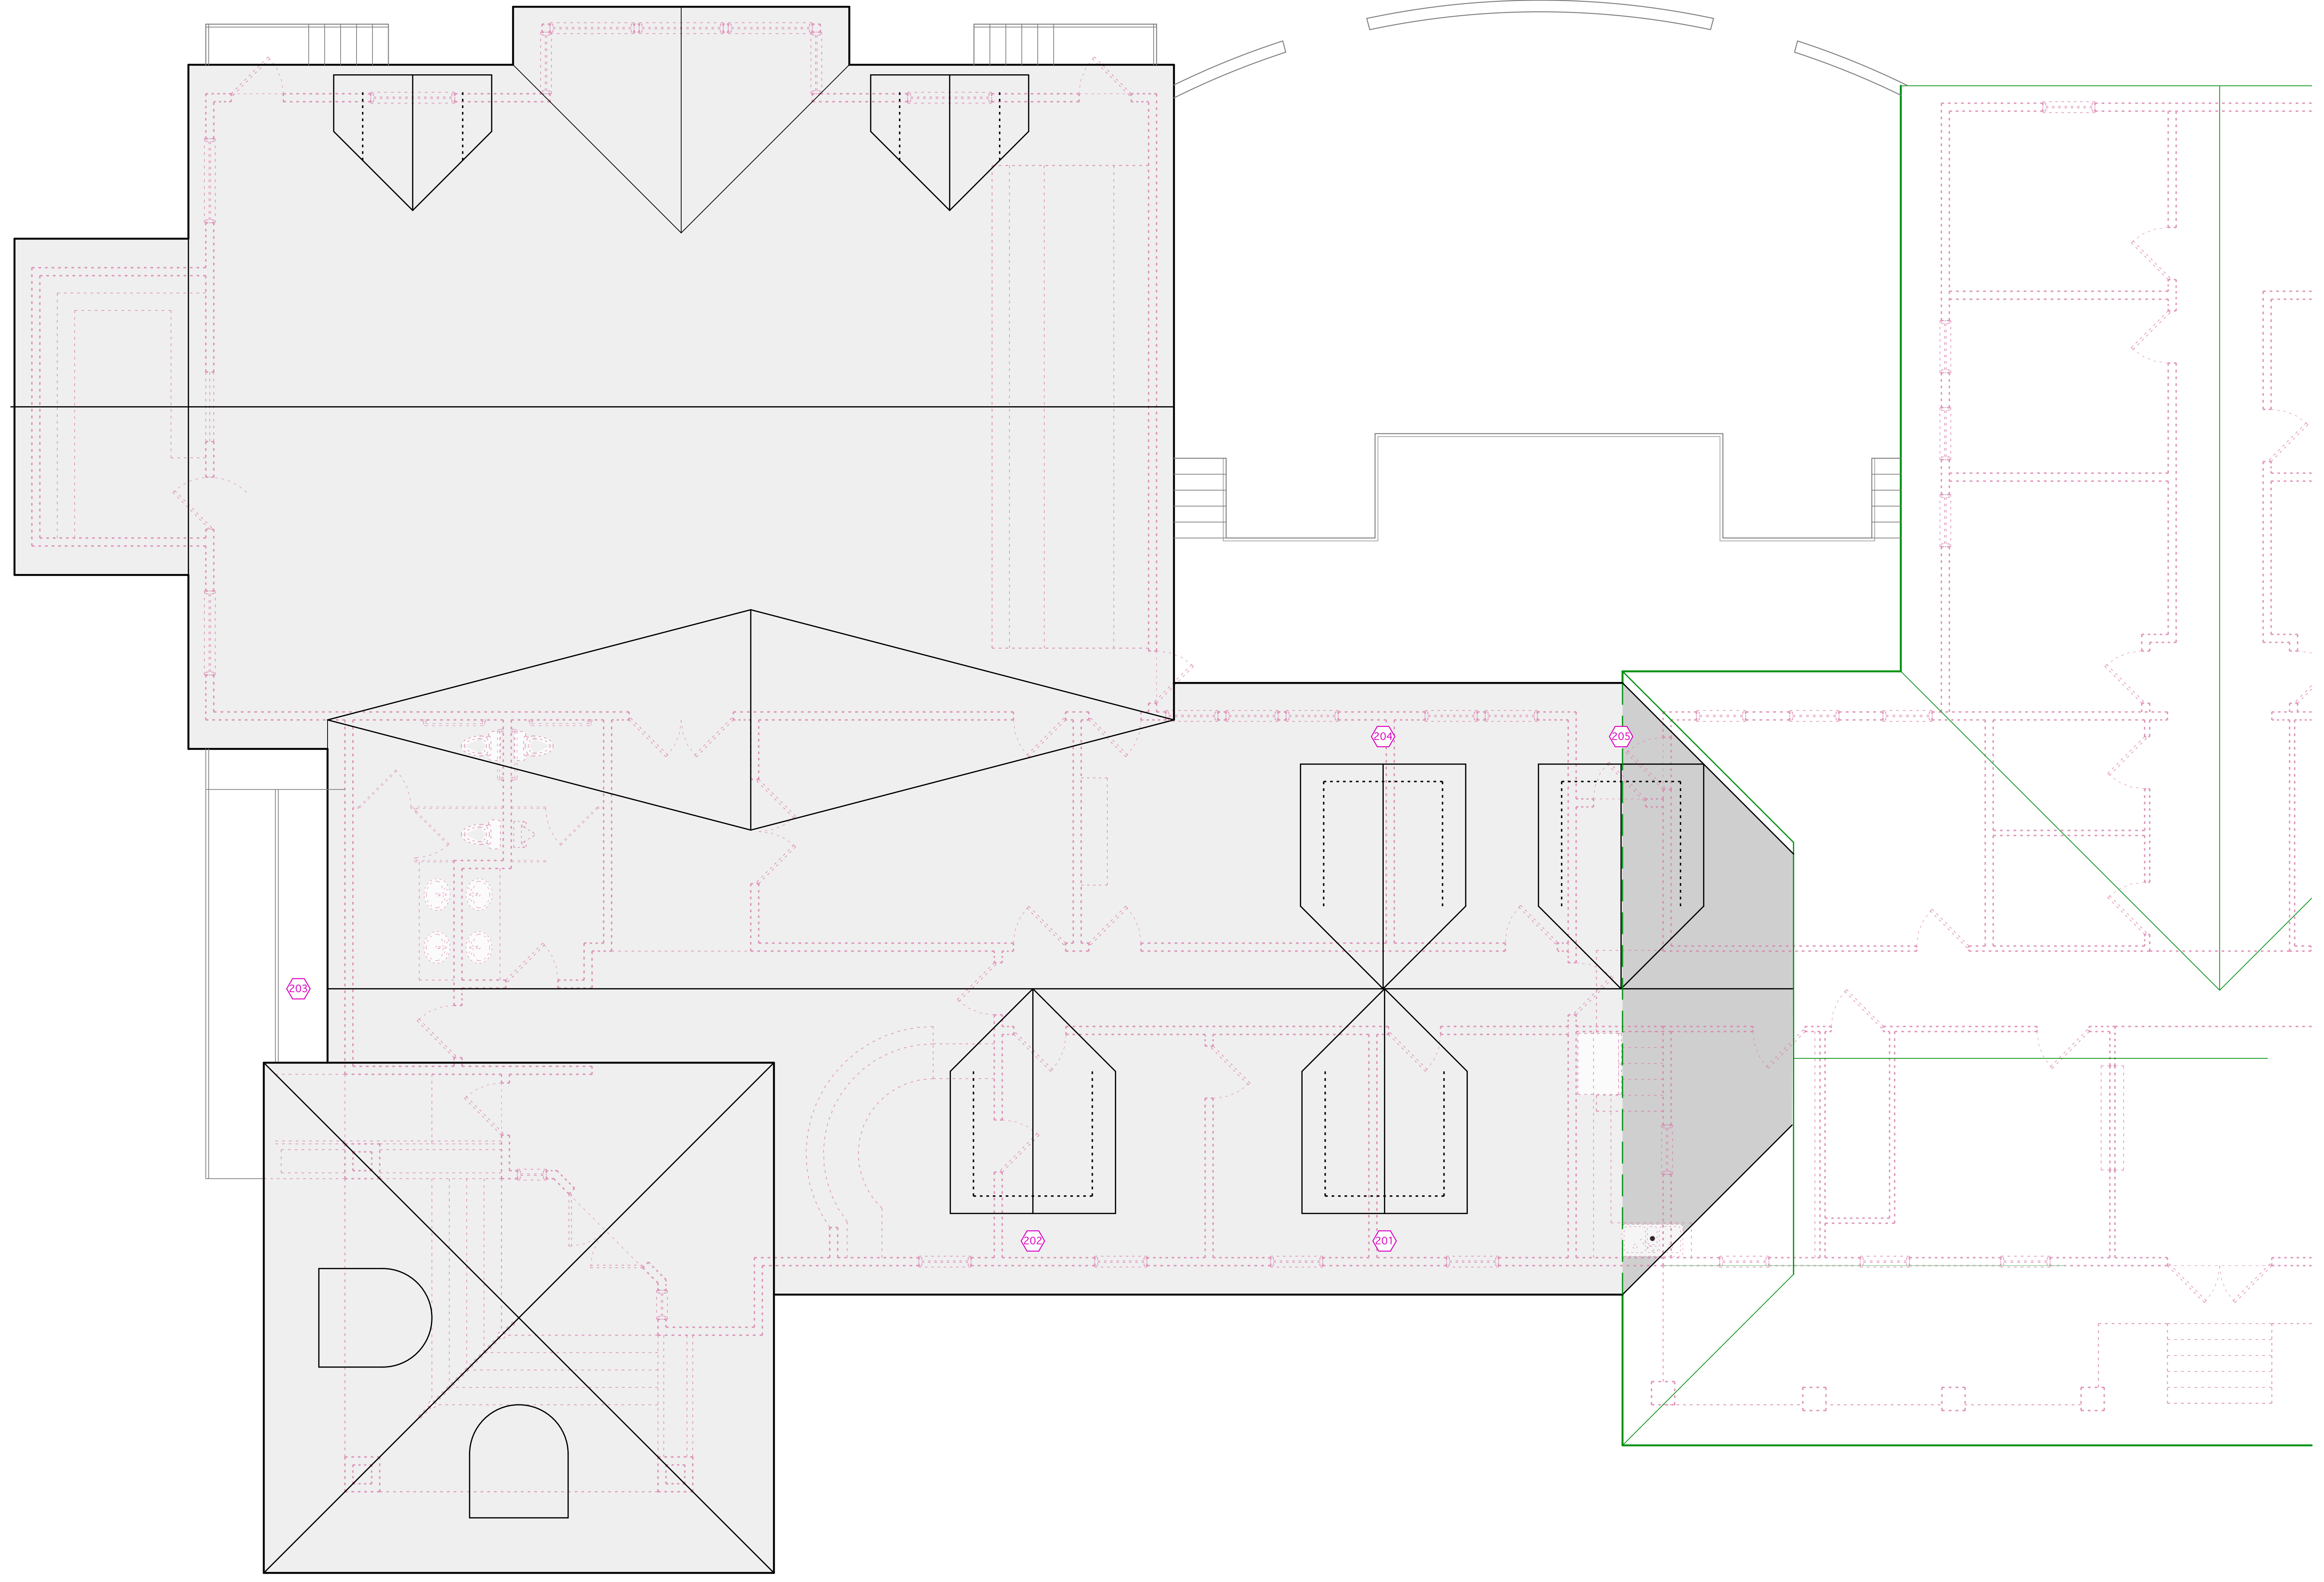

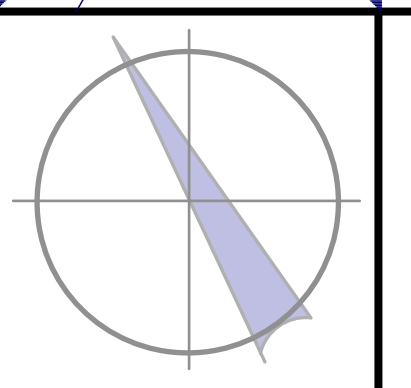
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Scale: 1/4"=1'-0" Drawn: MK Checked: MK

Date: MARCH 23, 2023 Drawing No.:


Commission No.: SC 2216A **A1.3**



Seabrook Municipal Center Alterations


Town of Seabrook Island
2001 Seabrook Island Rd
Seabrook Island, SC

Revisions:

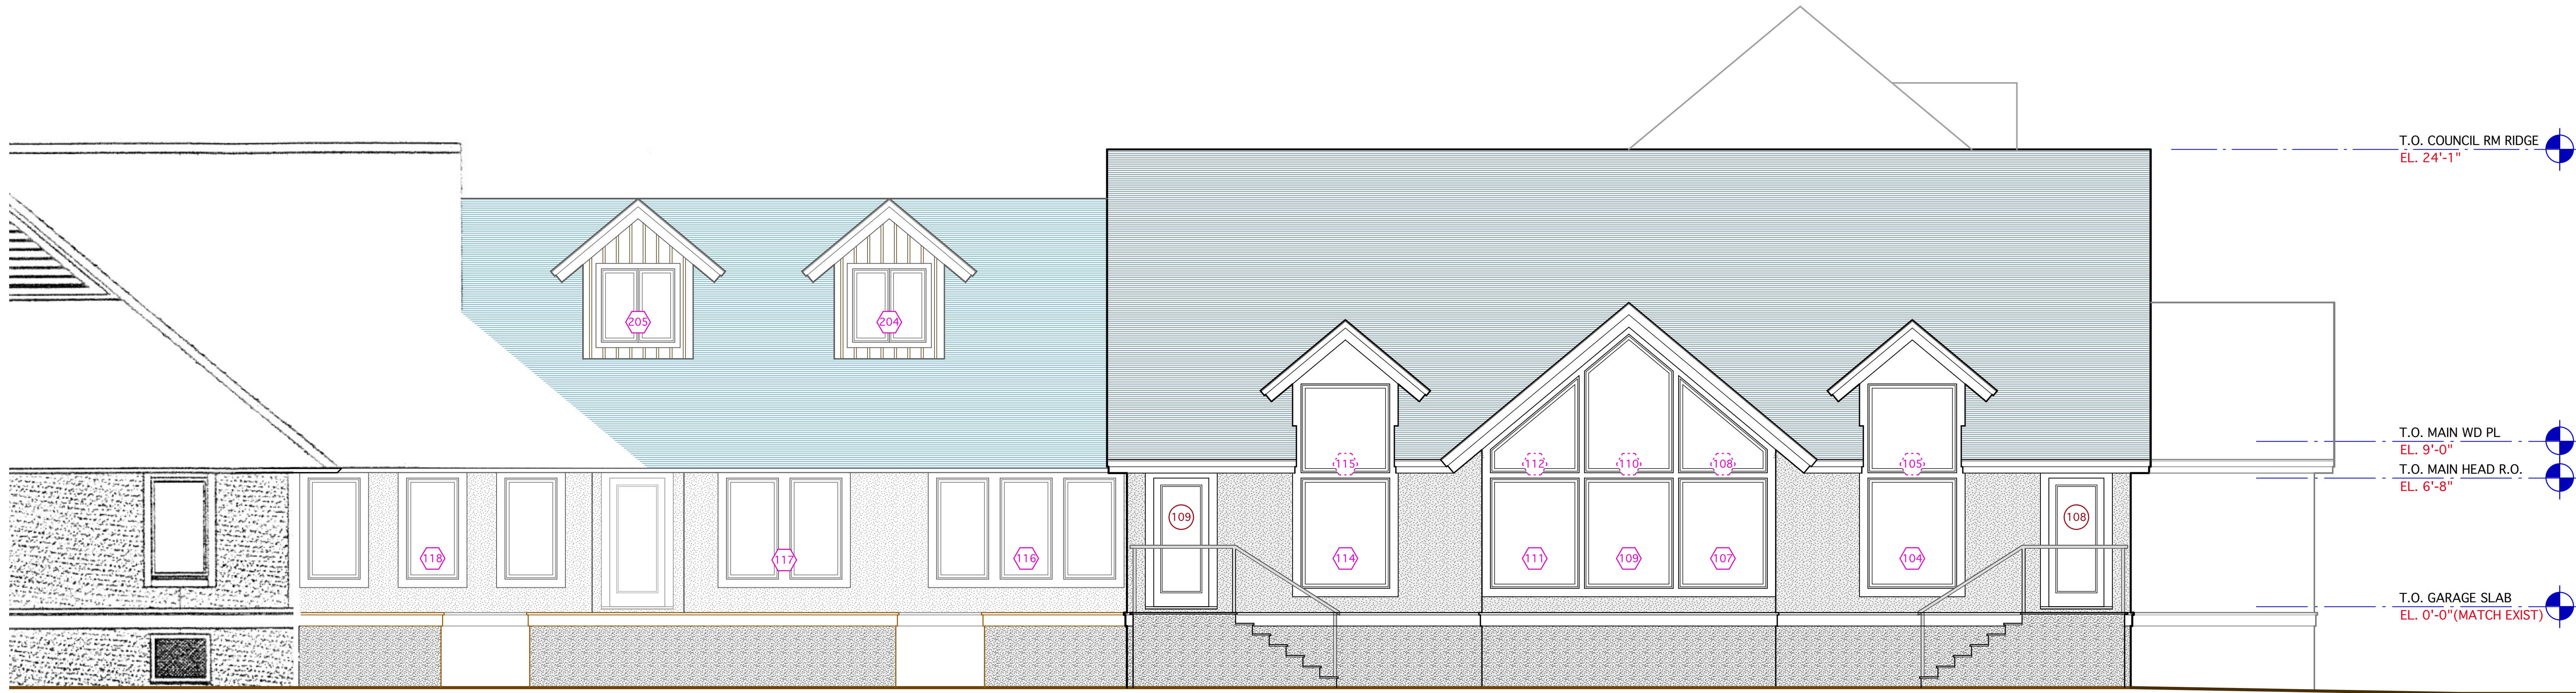

2 MUNICIPAL CENTER REAR ELEVATION

A2.1

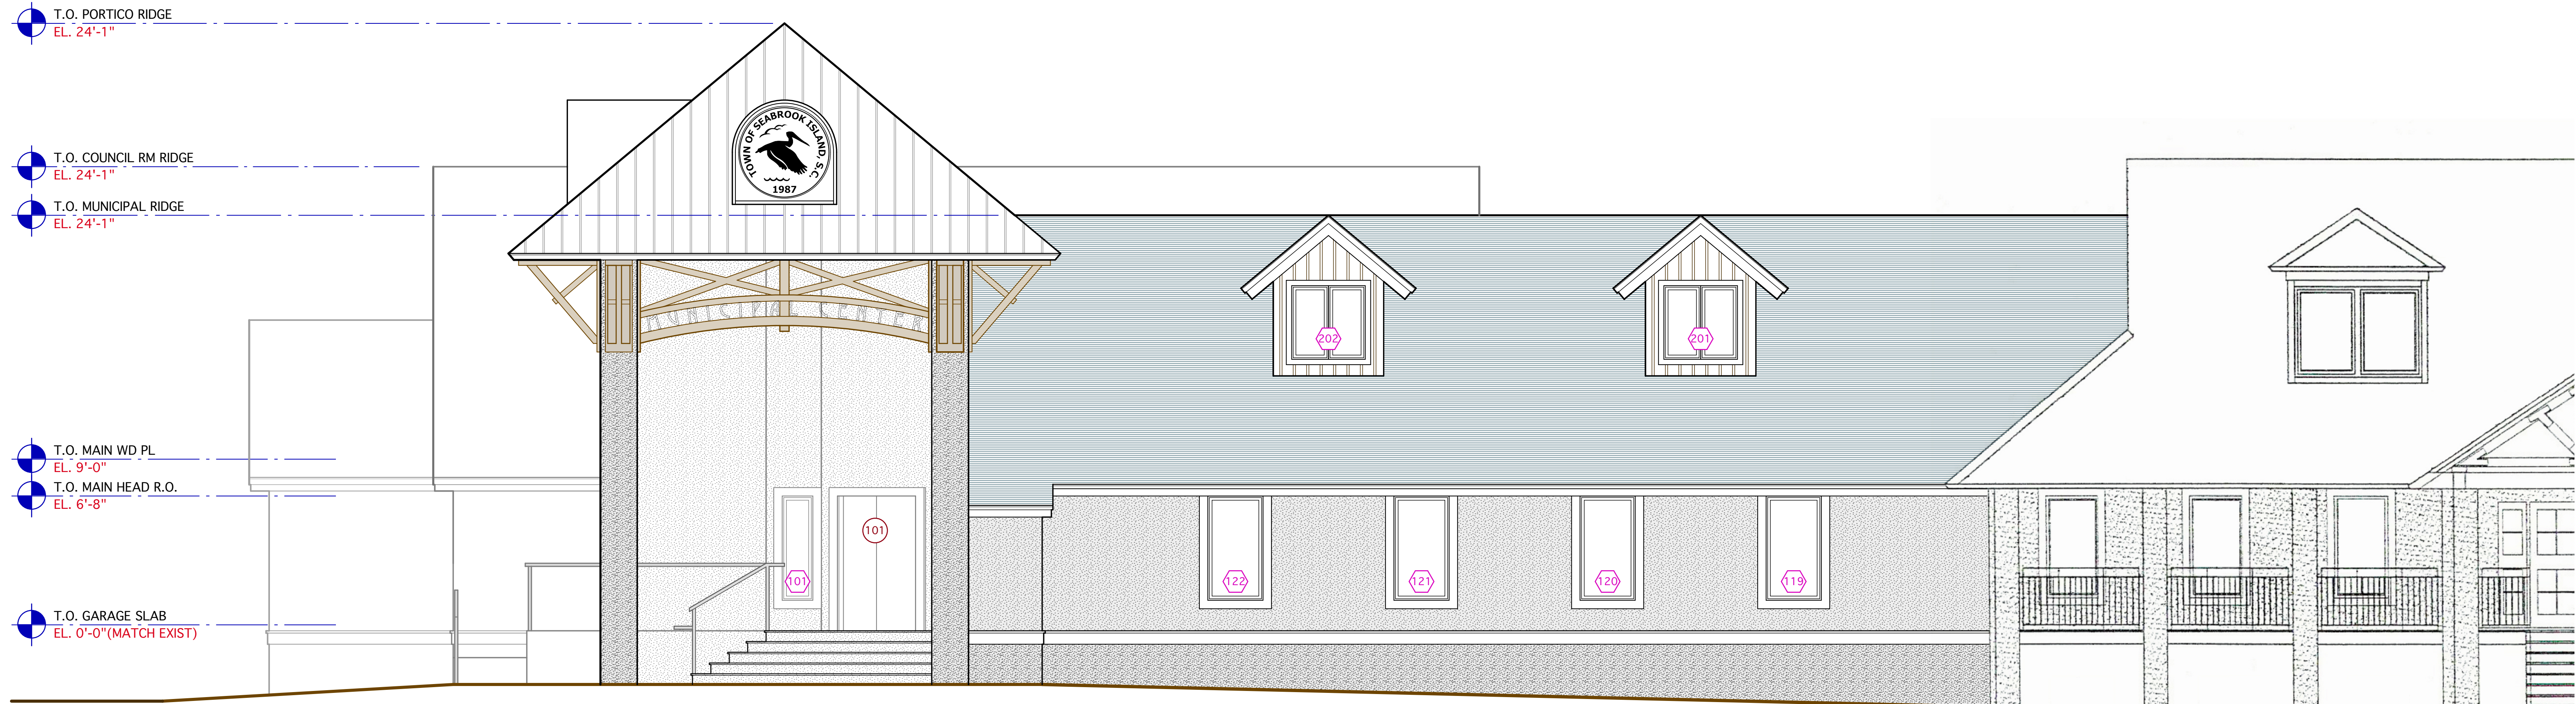


1 MUNICIPAL CENTER FRONT ELEVATION

A2.1

MUNICIPAL CENTER
EXTERIOR ELEVATIONS

MICHAEL E. KARAMUS
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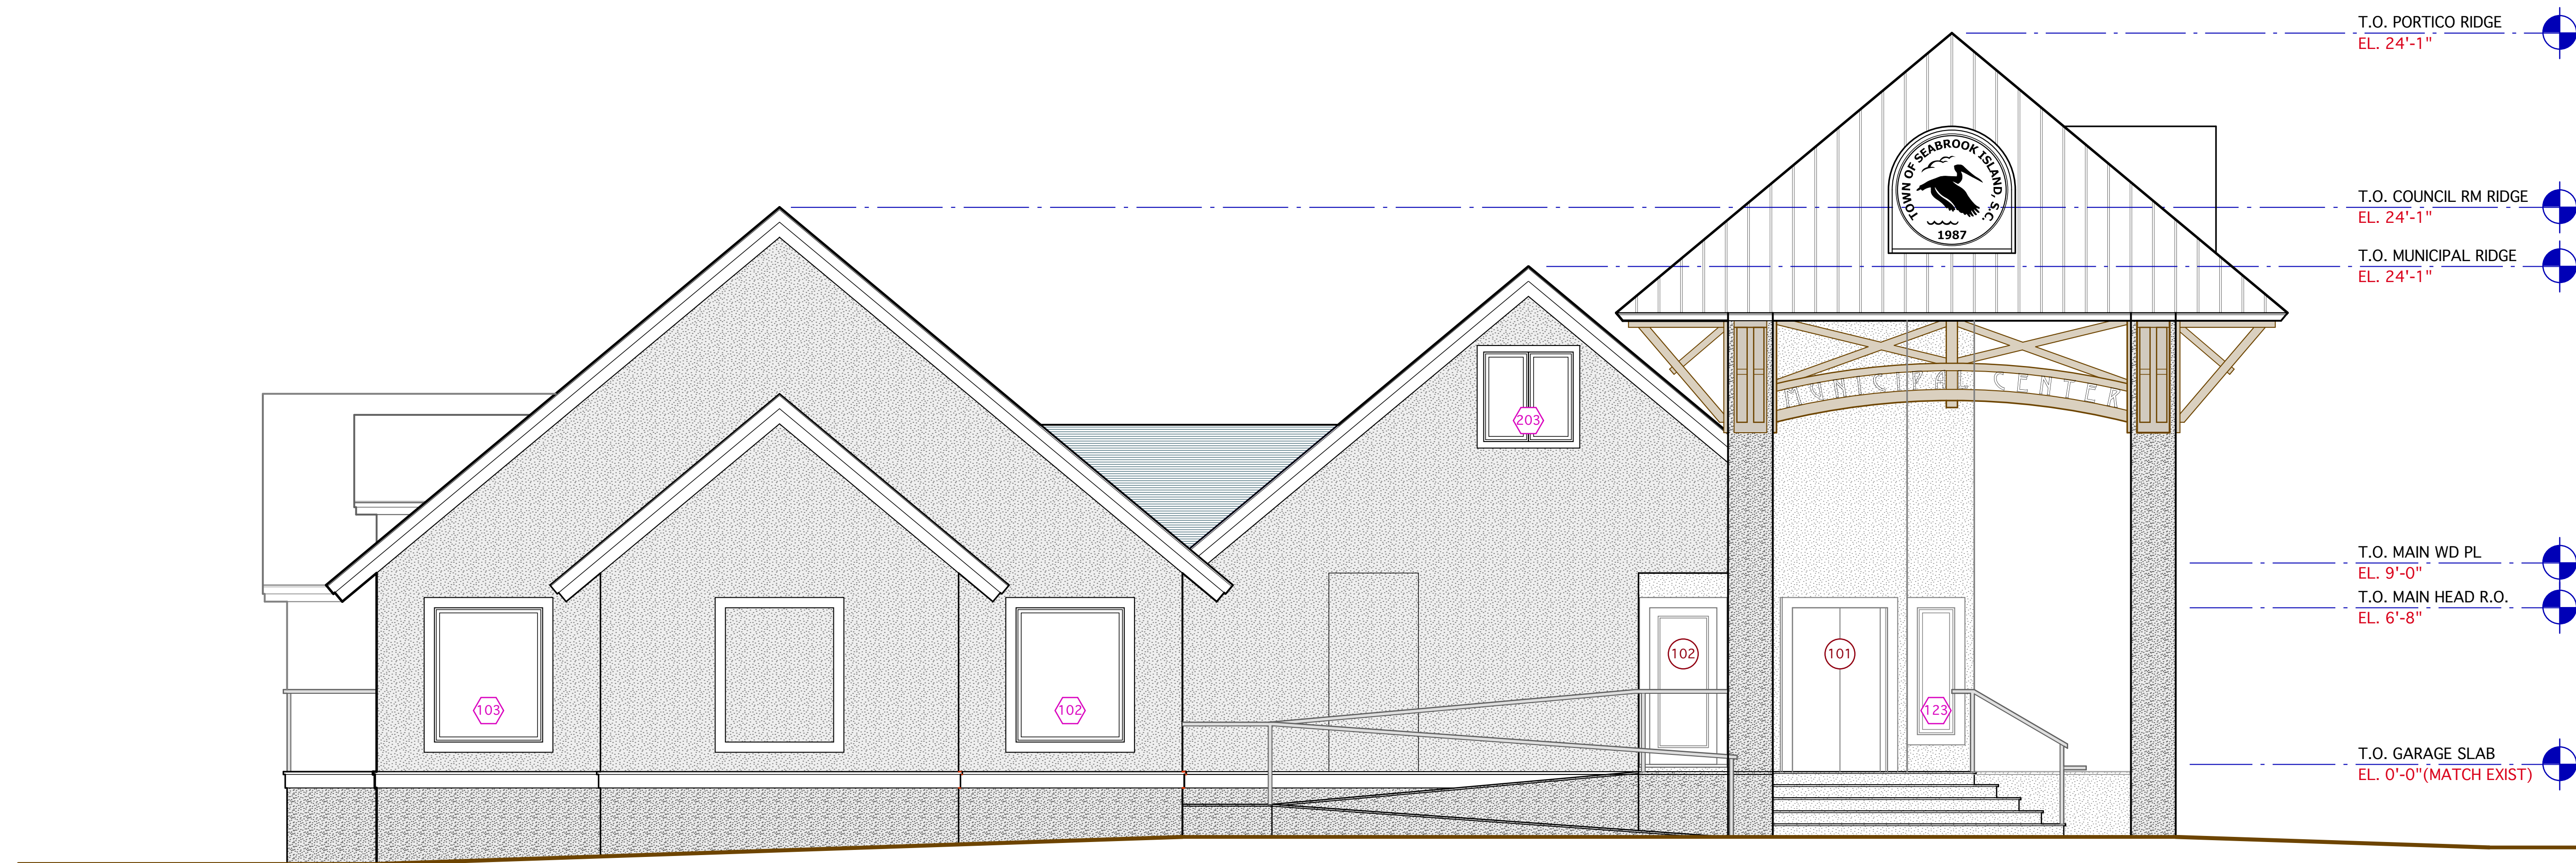
Commission No.: SC 2216A

A2.1

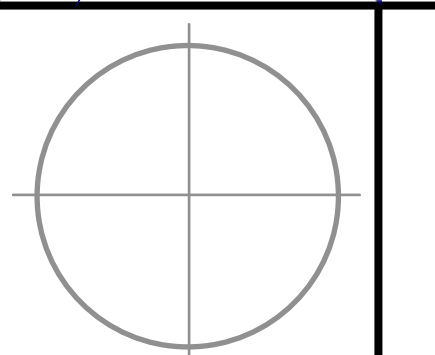Seabrook Municipal Center Alterations


Town of Seabrook Island
2001 Seabrook Island Rd
Seabrook Island, SC

Revisions:



EXTERIOR ELEVATIONS

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Scale: 1/4" = 1'-0" Drawn: MK Checked: MK

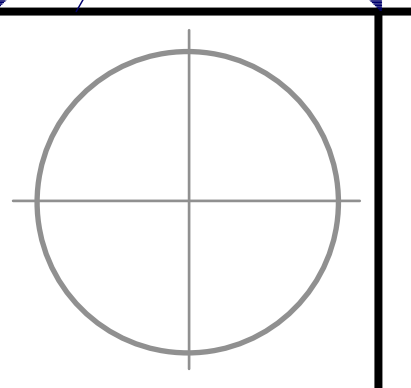Date: MARCH 23, 2023 Drawing No.:

Commission No.: SC 2216A **A2.2**

1 LEFT SIDE ELEVATION
A2.2


Seabrook Municipal Center Alterations

Town of Seabrook Island
2001 Seabrook Island Rd
Seabrook Island, SC

Revisions:



3 MUNICIPAL CENTER REAR ELEVATION
SD4a

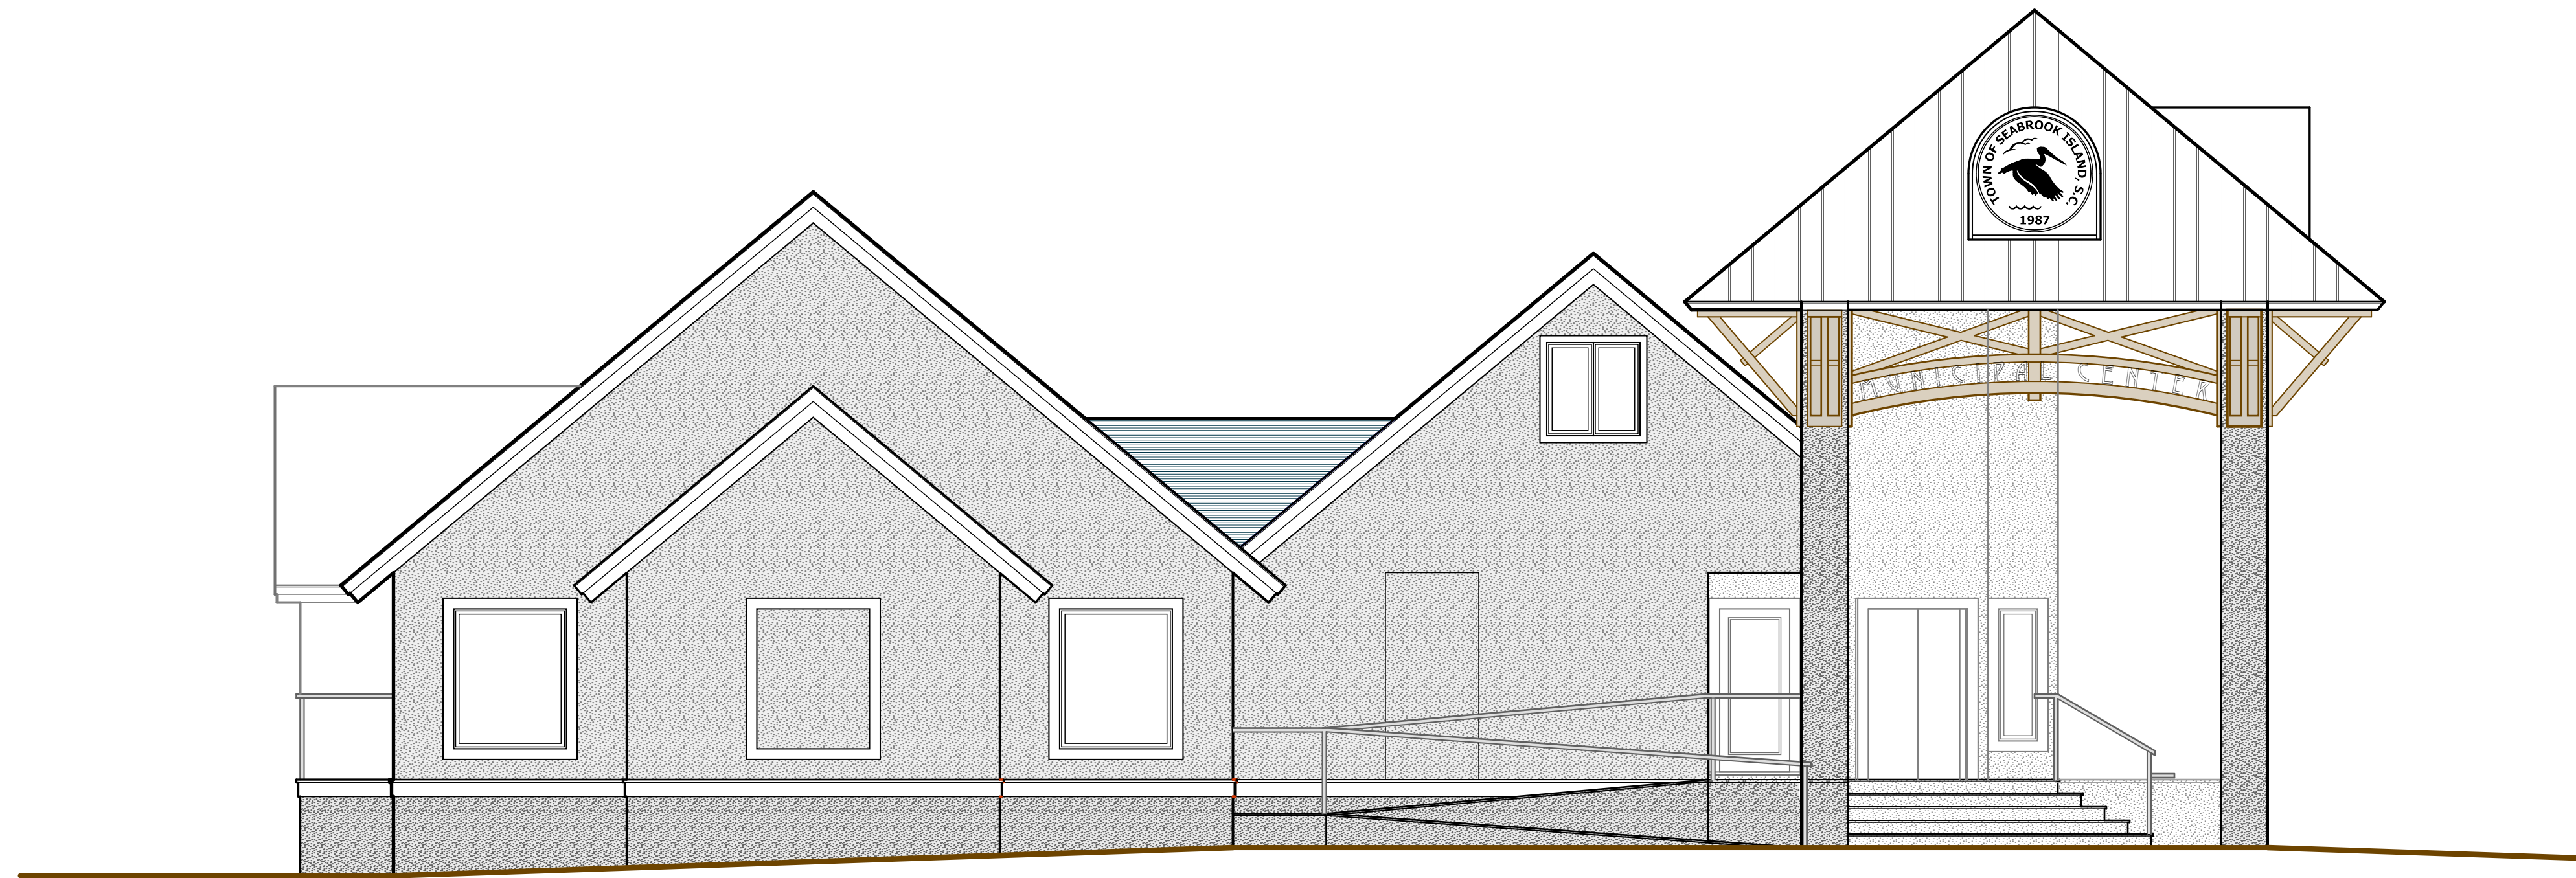

1 MUNICIPAL CENTER LEFT SIDE ELEVATION
SD5




1 MUNICIPAL CENTER FRONT ELEVATION
SD4a

MUNICIPAL CENTER
EXTERIOR ELEVATIONS

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Scale: 3/16"=1'-0" Drawn: MK Checked: MK

Date: JANUARY 6, 2023 Drawing No.:

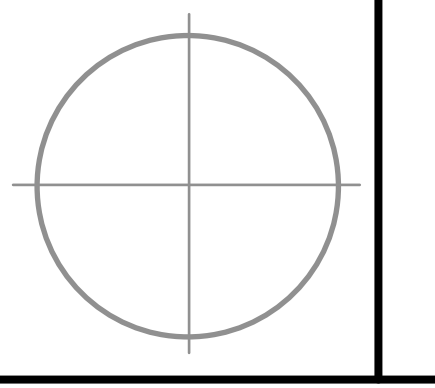Commission No.: SC 2216

SD4a

D O O R S C H E D U L E

ALL EXTERIOR DOOR UNITS TO BE FURNISHED WITH IMPACT RESISTANT GLAZING PER 2021IBC

DOOR	DOOR				FRAME		THRESHOLD	SCREEN	DETAILS			REMARKS
	WIDTH	HEIGHT	THICKNESS	TYPE	MAT/FINISH	THICKNESS			MAT/FINISH	TYPE	HEAD	
101	2'-3" - 0"	8' - 0"	1 3/4"	A	MET / NAT		MET / NAT					PAIR METAL STOREFRONT
102	3' - 0"	8' - 0"	1 3/4"	A	MET / NAT	5/4"	MET / NAT					METAL STOREFRONT
103	3' - 0"	8' - 0"	1 3/4"	B	MDF / PT	3/4"	WD. / PT.	MARBLE				
104	3' - 0"	8' - 0"	1 3/4"	B	MDF / PT	3/4"	WD. / PT.	MARBLE				
105	2'-3" - 0"	8' - 0"	1 3/4"	C	MDF / PT	3/4"	WD. / PT.					PAIR INTERIOR FRENCH DOORS
106	2'-3" - 0"	8' - 0"	1 3/4"	C	MDF / PT	3/4"	WD. / PT.					PAIR INTERIOR FRENCH DOORS
107	3' - 0"	8' - 0"	1 3/4"	B	MDF / PT	3/4"	WD. / PT.					
108	3' - 0"	8' - 0"	1 3/4"	D	MDF / PT	3/4"	WD. / PT.					
109	3' - 0"	8' - 0"	1 3/4"	D	MDF / PT	3/4"	WD. / PT.					
110	3' - 0"	8' - 0"	1 3/4"	D	MDF / PT	3/4"	WD. / PT.					
111	3' - 0"	8' - 0"	1 3/4"	B	MDF / PT	3/4"	WD. / PT.					
112	3' - 0"	8' - 0"	1 3/4"	B	MDF / PT	3/4"	WD. / PT.					
113	3' - 0"	8' - 0"	1 3/4"	B	MDF / PT	3/4"	WD. / PT.					
114	3' - 0"	8' - 0"	1 3/4"	B	MDF / PT	3/4"	WD. / PT.					
115	3' - 0"	8' - 0"	1 3/4"	B	MDF / PT	3/4"	WD. / PT.					
116	3' - 0"	8' - 0"	1 3/4"	E	WD / CLAD	5/4"	WD / CLAD	WOOD				
117	3' - 0"	8' - 0"	1 3/4"	E	WD / CLAD	5/4"	WD / CLAD	WOOD				
118	3' - 0"	8' - 0"	1 3/4"	F	MET / PT	5/4"	WD / CLAD	WOOD				GLAZED FIRE DOOR
119	3' - 0"	8' - 0"	1 3/4"	B	MDF / PT	3/4"	WD. / PT.					
120	3' - 0"	8' - 0"	1 3/4"	B	MDF / PT	3/4"	WD. / PT.					
121	3' - 0"	8' - 0"	1 3/4"	B	MDF / PT	3/4"	WD. / PT.					
122	3' - 0"	8' - 0"	1 3/4"	B	MDF / PT	3/4"	WD. / PT.					
122	3' - 0"	8' - 0"	1 3/4"	C	MDF / PT	3/4"	WD. / PT.					

W I N D O W S C H E D U L E

ALL WINDOW UNITS TO BE FURNISHED WITH IMPACT RESISTANT GLAZING PER 2021 IBC

NO.	TYPE	ROUGH OPENING		LITE CUT	MANUFACTURER	PRODUCT	SCREEN	JAMB	DETAILS			REMARKS
		WIDTH	HEIGHT						HEAD	JAMB	SILL	
101	A	2' - 0"	5' - 8"	1/1	ANDERSEN	DHP410510		6 11/16"	FH1	FJ1	FS1	CLAD FIXED (ROTATE 45°) SEE ELEV
102	B	4' - 10"	6' - 0"	1/1	ANDERSEN	DHP410510		6 11/16"	FH1	FJ1	FS1	CLAD FIXED
103	B	4' - 10"	6' - 0"	1/1	ANDERSEN	DHP410510		6 11/16"	FH1	FJ1	FS1	CLAD FIXED
104	B	4' - 10"	6' - 0"	1/1	ANDERSEN	DHP410510		6 11/16"	FH1	FJ1	FS1	CLAD FIXED
105	C	4' - 10"	4' - 0"	1/1	ANDERSEN	DHP410310		6 11/16"	FH1	FJ1	FS1	CLAD FIXED TRANSOM
106	B	3' - 6"	6' - 0"	1/1	ANDERSEN	DHP34510		6 11/16"	FH1	FJ1	FS1	CLAD FIXED
107	B	4' - 10"	6' - 0"	1/1	ANDERSEN	DHP410510		6 11/16"	FH1	FJ1	FS1	CLAD FIXED
108	D	4' - 10"	5' - 3"	1/1	ANDERSEN			6 11/16"	FH1	FJ1	FS1	CLAD FIXED TRIANGULAR TRANSOM
109	B	4' - 10"	6' - 0"	1/1	ANDERSEN	DHP410510		6 11/16"	FH1	FJ1	FS1	CLAD FIXED
110	E	4' - 10"	7' - 6"	1/1	ANDERSEN			6 11/16"	FH1	FJ1	FS1	CLAD FIXED TRIANGULAR TRANSOM
111	B	4' - 10"	6' - 0"	1/1	ANDERSEN	DHP410510		6 11/16"	FH1	FJ1	FS1	CLAD FIXED
112	D	4' - 10"	5' - 3"	1/1	ANDERSEN			6 11/16"	FH1	FJ1	FS1	CLAD FIXED TRIANGULAR TRANSOM
113	B	3' - 6"	6' - 0"	1/1	ANDERSEN	DHP34510		6 11/16"	FH1	FJ1	FS1	CLAD FIXED
114	B	4' - 10"	6' - 0"	1/1	ANDERSEN	DHP410510		6 11/16"	FH1	FJ1	FS1	CLAD FIXED
115	C	4' - 10"	4' - 0"	1/1	ANDERSEN	DHP410310		6 11/16"	DH1	DJ1	DS1	CLAD FIXED TRANSOM
116	F	8' - 0"	5' - 6"	1/1	ANDERSEN	CX155	✓	6 11/16"	CH1	CJ1	CS1	TRIPLE CLAD CASEMENT (6" MULL)
117	G	5' - 10"	5' - 6"	1/1	ANDERSEN	CX155	✓	6 11/16"	CH1	CJ1	CS1	DOUBLE CLAD CASEMENT (6" MULL)
118	H	2' - 8"	5' - 6"	1/1	ANDERSEN	CX155	✓	6 11/16"	CH1	CJ1	CS1	CLAD CASEMENT
119	H	2' - 8"	5' - 6"	1/1	ANDERSEN	CX155	✓	6 11/16"	CH1	CJ1	CS1	CLAD CASEMENT
120	H	2' - 8"	5' - 6"	1/1	ANDERSEN	CX155	✓	6 11/16"	CH1	CJ1	CS1	CLAD CASEMENT
121	H	2' - 8"	5' - 6"	1/1	ANDERSEN	CX155	✓	6 11/16"	CH1	CJ1	CS1	CLAD CASEMENT
122	H	2' - 8"	5' - 6"	1/1	ANDERSEN	CX155	✓	6 11/16"	CH1	CJ1	CS1	CLAD CASEMENT
123	A	2' - 0"	5' - 8"	1/1				6 11/16"	FH1	FJ1	FS1	CLAD FIXED (ROTATE 45°) SEE ELEV
201	I	4' - 0"	4' - 0"	1/1	ANDERSEN	C24	✓	6 11/16"	CH1	CJ1	CS1	PAIR CLAD CASEMENT
202	I	4' - 0"	4' - 0"	1/1	ANDERSEN	C24	✓	6 11/16"	CH1	CJ1	CS1	PAIR CLAD CASEMENT
203	I	4' - 0"	4' - 0"	1/1	ANDERSEN	C24	✓	6 11/16"	CH1	CJ1	CS1	PAIR CLAD CASEMENT
204	I	4' - 0"	4' - 0"	1/1		C24	✓	6 11/16"	CH1	CJ1	CS1	PAIR CLAD CASEMENT
205	I	4' - 0"	4' - 0"	1/1		C24	✓	6 11/16"	CH1	CJ1	CS1	PAIR CLAD CASEMENT

R O O M F I N I S H S C H E D U L E

RM #	NAME	FLOOR		BASE/TRIM TYPE		WALLS - MATERIAL / FINISH		CEILING			REMARKS
		MATERIAL	FINISH	TYPE	MAT/FINISH	CASING	HEIGHT	MAT/FINISH	CROWN		
101	PORTICO	CONC	BRICK			CEMENTITIOUS SIDING - PAINT		VARIES	WOOD - NAT	B	EXTERIOR SPACE
102	GREETING ROOM	PLYWD	BRICK	C	WD. - PAINT	GYP. BD. - PAINT	B	VARIES	GYP. BD. - PT.	C	
103	WOMEN	WOOD	NAT	C	WD. - PAINT	M. R. GYP. BD. - PAINT	B	9' - 0"	GYP. BD. - PT.	C	
104	MEN	WOOD	NAT	C	WD. - PAINT	GYP. BD. - PAINT	B	9' - 0"	GYP. BD. - PT.	C	
105	VESTIBULE	WOOD	NAT	B	WD. - PAINT	M. R. GYP. BD. - PAINT	C	9' - 0"	GYP. BD. - PT.	D	
106	CATERING	WOOD	NAT	B	WD. - PAINT	M. R. GYP. BD. - PAINT	C	9' - 0"	GYP. BD. - PT.	D	EQUIPMENT SPACE
107	COUNCIL CHAMBERS	WOOD	NAT	C	WD. - PAINT	GYP. BD. - PAINT	B	VARIES	GYP. BD. - PT.	C	
108	MEETING ROOM	PLYWD	STONE	C/B	WD. - PAINT	M. R. GYP. BD. - PAINT	B/C	9' - 0"	GYP. BD. - PT.	C/D	
109	MAYORS OFFICE	WOOD	NAT	C	WD. - PAINT	GYP. BD. - PAINT	B	9' - 0"	GYP. BD. - PT.	D	
110	ADMIN ASSISTANT	WOOD	NAT	C	WD. - PAINT	GYP. BD. - PAINT	B	9' - 0"	GYP. BD. - PT.	D	VAULTED SPACE - SEE A3/A6
111	TOWN ADMINISTRATOR	PLYWD	STONE	C	WD. - PAINT	M. R. GYP. BD. - PAINT	B	9' - 0"	GYP. BD. - PT.	D	
112	GALLERY	WOOD	NAT	C	WD. - PAINT	WD / GYP. BD. - PAINT	B	9' - 0"	GYP. BD. - PT.	C	BUILT IN BOOKCASE SPACE
113	STAFF ROOM	WOOD	NAT	B	WD. - PAINT	M. R. GYP. BD. - PAINT	C	9' - 0"	GYP. BD. - PT.	D	
114	COMMUNICATIONS	WOOD	NAT	C	WD. - PAINT	GYP. BD. - PAINT	B	9' - 0"	GYP. BD. - PT.	C	VAULTED SPACE - SEE A3/A6
115	RECORD STORAGE	WOOD	NAT	C	WD. - PAINT	WD / GYP. BD. - PAINT	B	9' - 0"	GYP. BD. - PT.	C	SHIPLAP ACCENT WALL - SEE A6
116	TOWN CLERK	WOOD	NAT	C	WD. - PAINT	GYP. BD. - PAINT	B	9' - 0"	GYP. BD. - PT.	D	BRICK COLUMNS & ARCHES - SEE A6
117	RECEPTION	IFE	NAT			CEMENTITIOUS SIDING - PAINT		9' - 0"			EXTERIOR SPACE

Seabrook Municipal Center Alterations


Town of Seabrook Island
2001 Seabrook Island Rd
Seabrook Island, SC

Revisions:

SCHEDULES & ELEVATIONS

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Johns Island, SC 29457

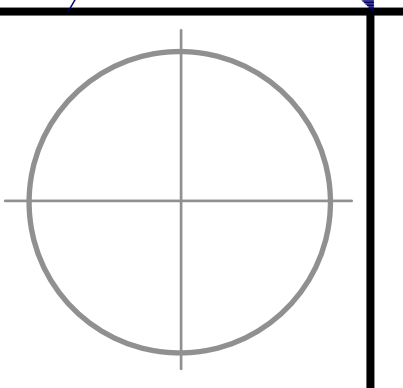

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Scale: AS NOTED	Drawn: MK	Checked: MK
Date: MARCH 23, 2023	Drawing No.: A7.1	
Commission No.: SC 2216A		

A

DOOR ELEVATIONS
SCALE: 3/4" = 1'-0"

AB	ANCHOR BOLT	E	EAST	L	LEADER	REFR	REFRIGERATOR
ABV	ABOVE	EA	EACH	LAB	LABORATORY	REG	REGISTER
AC	AIR CONDITION	EB	EXPANSION BOLT	LAD	LADDER	REIN	REINFORCE(D)(ING)
ACC	ACCESS	EBP	EXPOSED BLOCK PAINTED	LAM	LAMINATED	REM	REMOVE
ACD	ACCESS DOOR	EG	ESTABLISHED GRADE	LAV	LAVATORY	RET	RETURN
ACL	ACCESS FLOOR	EJ	EXPANSION JOINT	LBL	LABEL	REV	REVISION
ACP	ACCESS PANEL	EL	ELEVATION	LCL	LINEN CLOSET	RH	RIGHT HAND
ACR	ACRYLIC PLASTIC	ELEC	ELECTRICAL	LEN	LENGTH	RL	RAIL(ING)
ACT	ACOUSTICAL TILE	ELEV	ELEVATOR	LH	LEFT HAND	RM	ROOM
ACT MAS	ACOUSTICAL MASONRY UNIT	EMER	EMERGENCY	LIN	LINOLEUM	RO	ROUGH OPENING
ADD	ADDENDUM	EMG	EXPANDED METAL GUARD	LL	LIVE LOAD	ROW	RIGHT OF WAY
ADJ	ADJUSTABLE	ENCL	ENCLOSURE	LMS	LIMESTONE	S	SOUTH
ADJC	ADJACENT	ENT	ENTRANCE	LP	LOW POINT	SAC	SUSPENDED ACOUS CEILING
AFF	ABOVE FINISH FLOOR	EP	ELECTRIC PANEL	LT	LIGHT	SAD	SADDLE
AFG	ABOVE FINISH GRADE	EQ	EQUAL	LTL	LINTEL	SAE	SAME AS EXISTING
AGG	AGGREGATE	EQUIP	EQUIPMENT	LW	LIGHTWEIGHT	SAN	SANITATION
ALT	ALTERNATE	EST	ESTIMATE	LWC	LIGHTWEIGHT CONC	SC	SOLID CORE
ALUM	ALUMINUM	EX	EXAMPLE	LWCB	LIGHTWEIGHT CONC BLOCK	SCH	SCHEDULE
ANOD	ANODIZED	EXC	EXCAVATE	LVR	LOUVER	SCN	SCREEN
APPD	APPROVED	EXH	EXHAUST	MAD	METAL ACCESS DOOR	SCW	SOLID CORE WOOD
APX	APPROXIMATE	EXIST	EXISTING	MAR	MARBLE	SD	STORM DRAIN
ARCH	ARCHITECT(URAL)	EXP	EXPANSION	MAS	MASONRY	SEC	SECTION
ASC	ABOVE SUSP CLG	EXPS	EXT	MAT	MATERIAL	SFGL	SAFETY GLASS
ASPH	ASPHALT	EXT	EXTERIOR	MAX	MAXIMUM	SFT	STRUCTURAL FACING TILE
ASSEM	ASSEMBLY	F	FIXED	MB	MASTER BATH	SHL	SHIEL(VING)
AT	ASPHALT TILE	FA	FIRE ALARM	MBDRM	MASTER BEDROOM	SHT	SHEET
AUD	AUDITORIUM	FAS	FASTENER	MBR	MEMBER	SHL	SHIMLAR
AUTO	AUTOMATIC	FBD	FIBERBOARD	MC	MEDICINE CABINET	SL	SLEEVE
AUX	AUXILIARY	FBO	FURNISHED BY OTHERS	MCR	MEDICINE CABINET, RECESSED	SP	SPACE
&	AND	FC	FIRE CODE (CORE)	MECH	MECHANIC(AL)	SPEC	SPECIFICATION(S)
∠	ANGLE	FBRK	FIRE BRICK	MED	MEDIUM	SPF	SOUNDPROOF
@	AT	FCC	FLUSHED CONCRETE CURB	MEM	MEMBRANE	SPK	SPEAKER
BR	BRICK COURSE	FD	FLOOR DRAIN	MET	METAL	SQ. FT.	SQUARE FEET(FOOT)
BD	BOARD	FEC	FIRE EXTINGUISHER CABINET	MF	METAL FURRING	SQ. YD.	SQUARE YARD(S)
BE	BELOW	FER	FIRE EXTINGUISHER RECESS	MFD	METAL FLOOR DECKING	SS	STAINLESS STEEL
BFE	BASE FLOOD ELEVATION	FF	FACTORY FINISH	MFG	MANUFACTURE(ER)(ING)	STD	STANDARD
BFF	BELOW FINISH FLOOR	FH	FIRE HYDRANT	MHC	MANHOLE COVER	STL	STEEL
BFG	BELOW FINISH GRADE	FIN	FINISH(ED)	MIN	MINIMUM	STLPL	STEEL PLATE
BES	BRONZE EXPANSION SADDLE	FJT	FLUSH JOINT	MIR	MIRROR	STOR	STORAGE
BET	BETWEEN	FLASH	FLASHING	MIS	METAL INSECT SCREEN	STR	STRUCTURAL
BIT	BITUMINOUS	FLOOD	FLOOD	MISC	MISCELLANEOUS	SUBFL	SUBFLOORING
BL	BUILDING LINE	FLOR	FLUORESCENT	MLD	MOLDING	SUSP	SUSPENDED
BLDG	BUILDING	FLR	FLOOR	MNT	MOUNT(ED)(ING)	SYM	SYMMETRY(CAL)
BLK	BLOCK	FLT	FLUSH THREAD	MNO	MASONRY OPENING	SYN	SYNTHETIC
BLKG	BLOCKING	FMS	FLUSH MARBLE SADDLE	NOV	MOVABLE	SYS	SYSTEM
BM	BEAM	FND	FOUNDATION	NP	METAL PARTITION	T	TOILET
BOC	BOTTOM OF CURB	FOB	FACE OF BRICK	MRD	METAL ROOF DECKING	TC	TERRAZZO
BOB	BOTTOM	FOC	FACE OF CONCRETE	MS	METAL STRIP	TEL	TELEPHONE
BOW	BOTTOM OF WALL	FOF	FACE OF FINISH	MTHR	METAL THRESHOLD	TERR	TERRAZZO
BPL	BEARING PLATE	FOM	FACE OF MASONRY	MULL	MULLION	TERR	TERRAZZO
BRG	BEARING	FOS	FACE OF STUD	N	NORTH	THK	THICK(NESS)
BRK	BRICK	FP	FIRE PROOF(ING)	NAT	NATURAL	THR	THRESHOLD
BRZ	BRONZE	FPL	FIREPLACE	ND	NOMINAL DIAMETER	TKBD	TACKBOARD
BS	BOTH SIDES	FLPT	FLOOR PLATE	NIC	NOT IN CONTRACT	TO	TRIMMED OPENING
BSM	BASEMENT	FR	FRAME(D)(ING)	NO	NUMBER	TOF	TOP OF FOOTING
BVL	BEVELED	FR GYP BD	FIRE RATED GYPSUM BOARD	NOM	NOMINAL	TOSL	TOP OF SLAB
CAB	CABINET	FS	FLOOR SINK	NR	NOISE REDUCTION	TOS	TOP OF STEEL
CAFE	CAFETERIA	FT	FOOT/FEET	NRC	NOISE REDUCTION COEFFICIENT	TOW	TOP OF WALL
CARP	CARPET	FTG	FOOTING	NTS	NOT TO SCALE	TPTN	TOILET PARTITION
CB	CATCH BASIN	FUT	FUTURE	OA	OVERALL	TR	TRANSOM
CEM	CEMENT	FVS	FLUSH VINYL SADDLE	OAI	OUTSIDE AIR INTAKE	TRD	TREAD
CEM	CERAMIC	GA	GUAGE	OC	ON CENTER	TV	TELEVISION
CG	CORNER GUARD	GALV	GALVANIZED	OD	OUTSIDE DIAMETER	TYP	TYPICAL
CI	CAST IRON	GB	GLAZED BLOCK	OE	OWNER FURNISHED EQUIPMENT	T&G	TONGUE AND GROOVE
CIR	CIRCLE	GC	GENERAL CONTRACTOR	OFF	OFFICE	UNF	UNFINISHED
CIRC	CIRCUMFERENCE	GCMU	GLAZED CMU	OF	OVER FLOW SCUPPER	UV	UNIT VENTILATOR
CJ	CONTROL JOINT	GD	GRADE(ING)	OH	OVERHEAD	UR	URINAL
CL	CENTER LINE	GDBM	GRADE BEAM	OP	OPENING	VAT	VINYL ASBESTOS TILE
CLG	CEILING	GDEL	GRADE ELEVATION	OPH	OPPOSITE HAND	VAR	VARNISH
CLL	CONTRACT LIMIT LINE	GDEL	GRADE ELEVATION	OPP	OPPOSITE	VB	VINYL BASE
CLOS	CLOSET	GI	GALVANIZED IRON	OSB	ORIENTED STRAND BOARD	VCT	VINYL COMPOSITION TILE
CLR	CLEAR(ANCE)	GL	GLASS	PAR	PARALLEL	VERT	VERTICAL
CLS	CLOSURE	GLF	GLASS FIBER	PART	PARTITION	VG	VERTICAL GRAIN
CMT	CERAMIC MOSAIC TILE	GR	GRILLE	PB	PANIC BAR	VN	VINYL
CMU	CONC MASONRY UNIT	GRN	GRANITE	PB	PARTICLE BOARD	VNF	VINYL FABRIC
COL	COLUMN	GRND	GROUND	PFC	POUNDS PER CUBIC FOOT	VPB	VAPOR BARRIER
COMP	COMPOSITION	GT	GROUT	PE	PORCELIN ENAMEL	VJR	"V" JOINT(ED)
CON	CONNECTION	GV	GAS VALVE	PER	PERIMETER	VJ	VENEER
CONC	CONCRETE	GVP	GYP VERMICULITE PLASTER	PERF	PERFORATE(D)	VNT	VINYL TILE
CONST	CONSTRUCTION	GWT	GLAZED WALL TILE	PFB	PREFABRICATE(D)	VWC	VINYL WALL COVERING
CONT	CONTINUOUS	GYP BD	GYPSUM BOARD	PL	PLATE	W	WEST
CONTR	CONTRACT(OR)	H	HIGH	PLM	PLASTIC LAMINATE	W/	WITH
COR	CORRIDOR	HB	HOSE BIB	PLAS	PLASTER	WB	WOOD BASE
CORR	CORRUGATED	HBD	HARDBOARD	PLATF	PLATFORM	WC	WATER CLOSET
CPR	COPPER	HC	HOLLOW CORE	PLF	POUNDS PER LINEAR FOOT	WD	WOOD
CRS	COURSE(S)	HD	HEAVY DUTY	PLT	PLATE	WDWT	WOOD WAINSCOT
CSMT	CASEMENT	HD	HEAVY DUTY	PLF	POUNDS PER LINEAR FOOT	WG	WIRED GLASS
CST	CAST STONE	HDCP	HANDICAPPED	PLY	PLYWOOD	WH	WALL HUNG
CMT	CERAMIC TILE	HDWR	HARDWARE	PLUM	PLUMBING	WH	WIDE(WIDTH)
CU. FT	CUBIC FEET	HDR	HEADER	PLM	PLUMBING	WIN	WINDOW
CU. YD	CUBIC YARD	HGT	HEIGHT	PNL	PANEL	WIN	WINDOW
D	DRAIN	HM	HOLLOW METAL	PNT	PAINT(ED)	WM	WIRE MESH
DA	DOUBLE ACTING	HNDR	HAND RAIL	PRT	PRESSURE TREATED	WO	WITHOUT
DB	DISPLAY BOARD	HOR	HORIZONTAL	PSF	POUNDS PER SQUARE FOOT	WP	WATERPROOFING
DBL	DOUBLE	HP	HIGH POINT	PSI	POUNDS PER SQUARE INCH	WSCT	WAINSCOT
DC	DUST CHUTE	HR	HOUR(LY)	PTT	PRECAST TERRAZZO TILE	WWF	WELED WIRE FABRIC
DEP	DEPRESSED	HTG	HEATING	PVC	POLYVINYL CHLORIDE		
DEPT	DEPARTMENT	HVAC	HEATING VENT & AIR COND	PVMT	POLYVINYL		
DET	DETAIL	HWH	HOT WATER HEATER	QT	QUARRY TILE		
DF	DRINKING FOUNTAIN	ID	INSIDE DIAMETER	R	RISER		
DH	DOUBLE HUNG	INCL	INCLUDE (D)(ING)	R	RADIUS		
DIA	DIAMETER	INSUL	INSULATION (D)(ION)	RAD	RADIUS		
DIAG	DIAGONAL	INT	INTERIOR	RAG	RETURN AIR GRILLE		
DIM	DIMENSION	INTM	INTERMEDIATE	RB	RUBBER BASE		
DISP	DISPENSER	JT	JOINT	RBL	RUBBLE STONE		
DISP CAB	DISPLAY CABINET	JF	JOINT FILLER	RBT	RABBIT		
DL	DEAD LOAD	KP	KICKPLATE	RBL	RUBBER TILE		
DN	DOWN	KPC	REINFORCED CONC PIPE	RCP	ROOF DRAIN		
DN	DITTO	KIT	KITCHEN	REC	RECESS(ED)		
DP	DAMP/ROOFING	KO	KNOCKOUT	REF	REFLECT(ED)(IVE)(OR)		
DPR	DAMPER						
DR	DOOR						
DS	DOWNSPOUT						
DTL	DRAIN TILE						
DTL	DETAIL						
DWG	DRAWING						


4 ABBREVIATIONS

2 LOCATER MAP

2 IBC TABLE 506.2

1 GENERAL NOTES

7 IBC TABLE 601 / 602

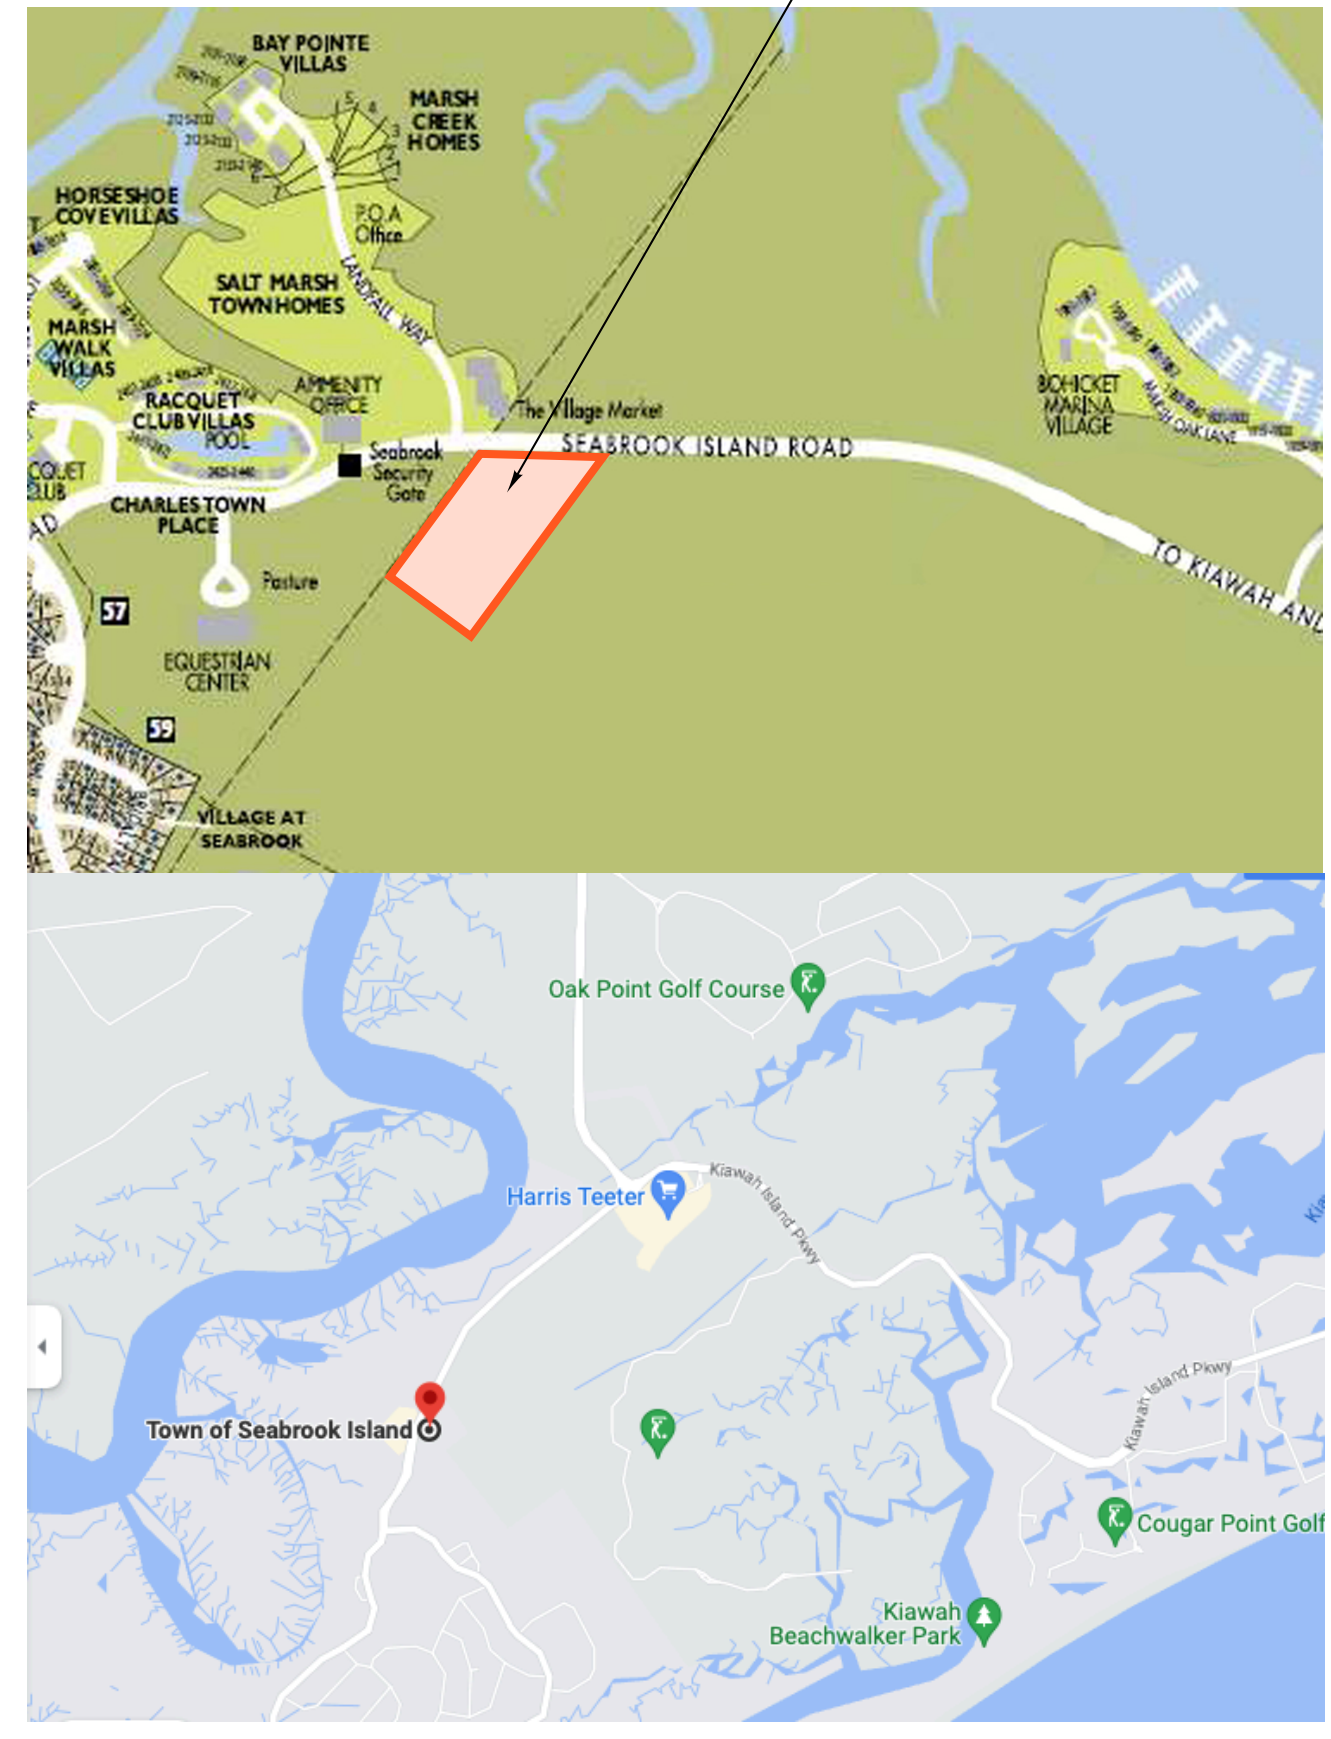

6 IBC TABLE 504.4

OCCUPANCY CLASSIFICATION	SEE FOOTNOTES	TYPE OF CONSTRUCTION						
		TYPE I		TYPE II		TYPE III		
A	B	A	B	A	B	A	B	
I-1	NS ¹	55,000	19,000	10,000	16,500	10,000	10,500	4,500
	S ¹	220,000	76,000	40,000	66,000	40,000	72,000	18,000
I-2	NS ¹	165,000	57,000	30,000	49,500	30,000	31,500	13,500
	S ¹	15,000	11,000	12,000	NP ²	12,000	9,500	NP ²
I-3	NS ¹	60,500	26,500	13,000	23,500	13,000	25,500	9,000
	S ¹	121,000	106,000	52,000	94,000	52,000	102,000	74,000
I-4	NS ¹	181,500	79,500	39,000	70,500	39,000	76,500	27,000
	S ¹	21,500	12,500	18,500	12,500	20,500	14,000	9,000
M	NS ¹	86,000	50,000	74,000	50,000	82,000	56,000	36,000
	S ¹	64,500	37,500	55,500	37,500	61,500	42,000	27,000
R-1	NS ¹	24,000	16,000	24,000	16,000	20,500	12,000	7,000
	S ¹	96,000	64,000	96,000	64,000	82,000	48,000	28,000
R-2	NS ¹	72,000	48,000	72,000	48,000	61,500	36,000	21,000
	S ¹	24,000	16,000	24,000	16,000	20,500	12,000	7,000
R-3	NS ¹	96,000	64,000	96,000	64,000	82,000	48,000	28,000
	S ¹	72,000	48,000	72,000	48,000	61,500	36,000	21,000
R-4	NS ¹	24,000	16,000	24,000	16,000	20,500	12,000	7,000
	S ¹	96,000	64,000	96,000	64,000	82,000	48,000	28,000
S-1	NS ¹	48,000	28,000	17,500	28,000	17,500	25,500	9,000
	S ¹	182,000	104,000	70,000	104,000	70,000	102,000	36,000
S-2	NS ¹	144,000	78,000	52,500	78,000	52,500	76,500	42,000
	S ¹	79,000	39,000	26,000	26,000	38,500	21,000	13,500
U	NS ¹	316,000	156,000	104,000	156,000	104,000	154,000	84,000
	S ¹	237,000	117,000	78,000	117,000	78,000	115,500	63,000

5 MATERIAL SYMBOLS

- GENERAL NOTES:**
- ALL INFORMATION BASED ON 2021 INTERNATIONAL BUILDING CODE & SC STATE AMENDMENTS
- OCCUPANCY CLASSIFICATION:**
LOW HAZARD STORAGE: BUSINESS GROUP S-2 STORAGE USES SHALL INCLUDE, BUT NOT BE LIMITED TO, STORAGE OF THE FOLLOWING:
ENCLOSED PRIVATE PARKING GARAGE
 - AREA OF BUILDING:**
AREA OF MAIN FLOOR GARAGE: 2,634 SQ FT
AREA OF MAIN FLOOR CONDITIONED: 736 SQ FT
AREA OF EXTERIOR STORAGE: 330 SQ FT
AREA OF EULTRIE OFFICE: 1,480 SQ FT
TOTAL HEATED AREA: 2,236 SQ FT
 - HEIGHT OF BUILDING:**
HEIGHT OF BUILDING ABOVE AVERAGE GRADE: 45'-10 3/4"
HEIGHT OF BUILDING ABOVE DESIGN FLOOD ELEV: 39'-2 3/4"
NO. OF STORIES - 1-1/2
 - CONSTRUCTION CLASSIFICATION:**
BUILDING SHALL BE TYPE III CONSTRUCTION. TYPE III IS THAT TYPE OF CONSTRUCTION IN WHICH THE EXTERIOR WALLS ARE OF NONCOMBUSTIBLE MATERIALS AND THE INTERIOR BUILDING ELEMENTS ARE OF ANY MATERIAL PERMITTED BY THIS CODE.
 - BUILDING INSULATION:**
MAIN FLOOR - SLAB ON GRADE
EXTERIOR WALLS - 6" FIBERGLASS BATT INSULATION MIN. R-19
CEILING / ROOF - OPEN CELL SPRAY FOAM INSULATION MIN. R-30


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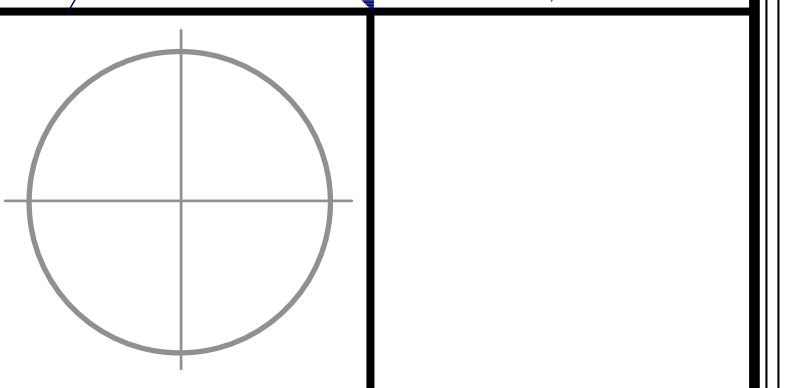
- SYMBOL**
- USE**
- 1 FRONT ELEVATION DRAWING TITLE
 - 10.00' MSL ELEVATION INDICATOR
 - 1 Slab Elevation
 - 1 First Floor Elevation = 0'-0"
 - 1 AS.1 DETAIL CUT
 - 2 AS.2 BLDG SECTION CUT
 - 2 AS.3 EXT. ELEV. INDICATOR
 - 4 A6.1 INT. ELEV. INDICATOR
 - 6 A4.3 DETAIL INDICATOR
 - 101 ROOM No. INDICATOR
 - 101 DOOR No. INDICATOR
 - 101 WINDOW No. INDICATOR
 - 101 WORKNOTE INDICATOR
 - 12 ROOF PITCH INDICATOR

8 DRAWING SYMBOLS




GENERAL PROJECT INFORMATION

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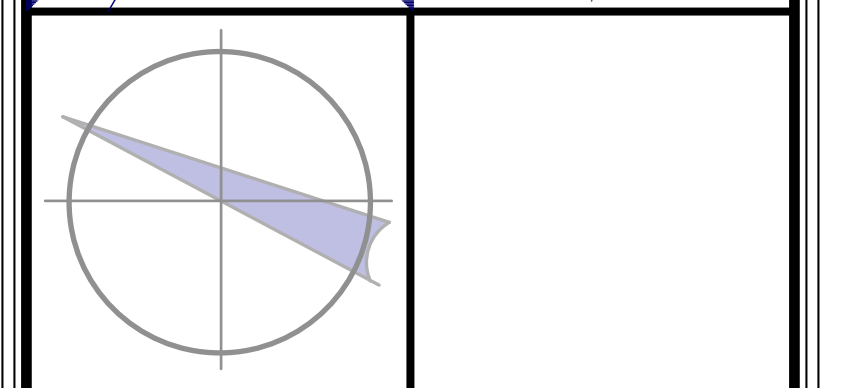
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PROPOSED SITE LAYOUT
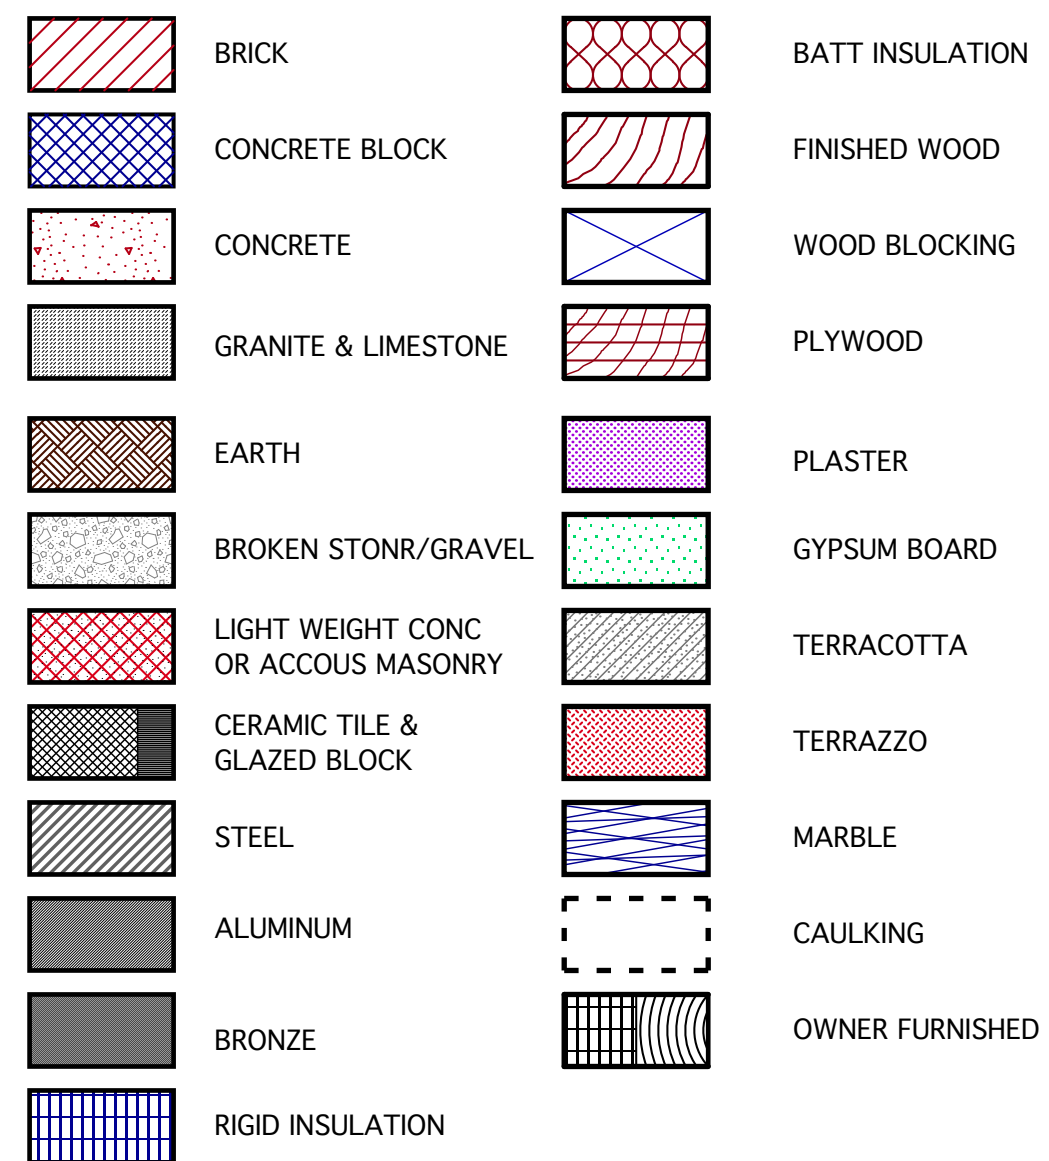
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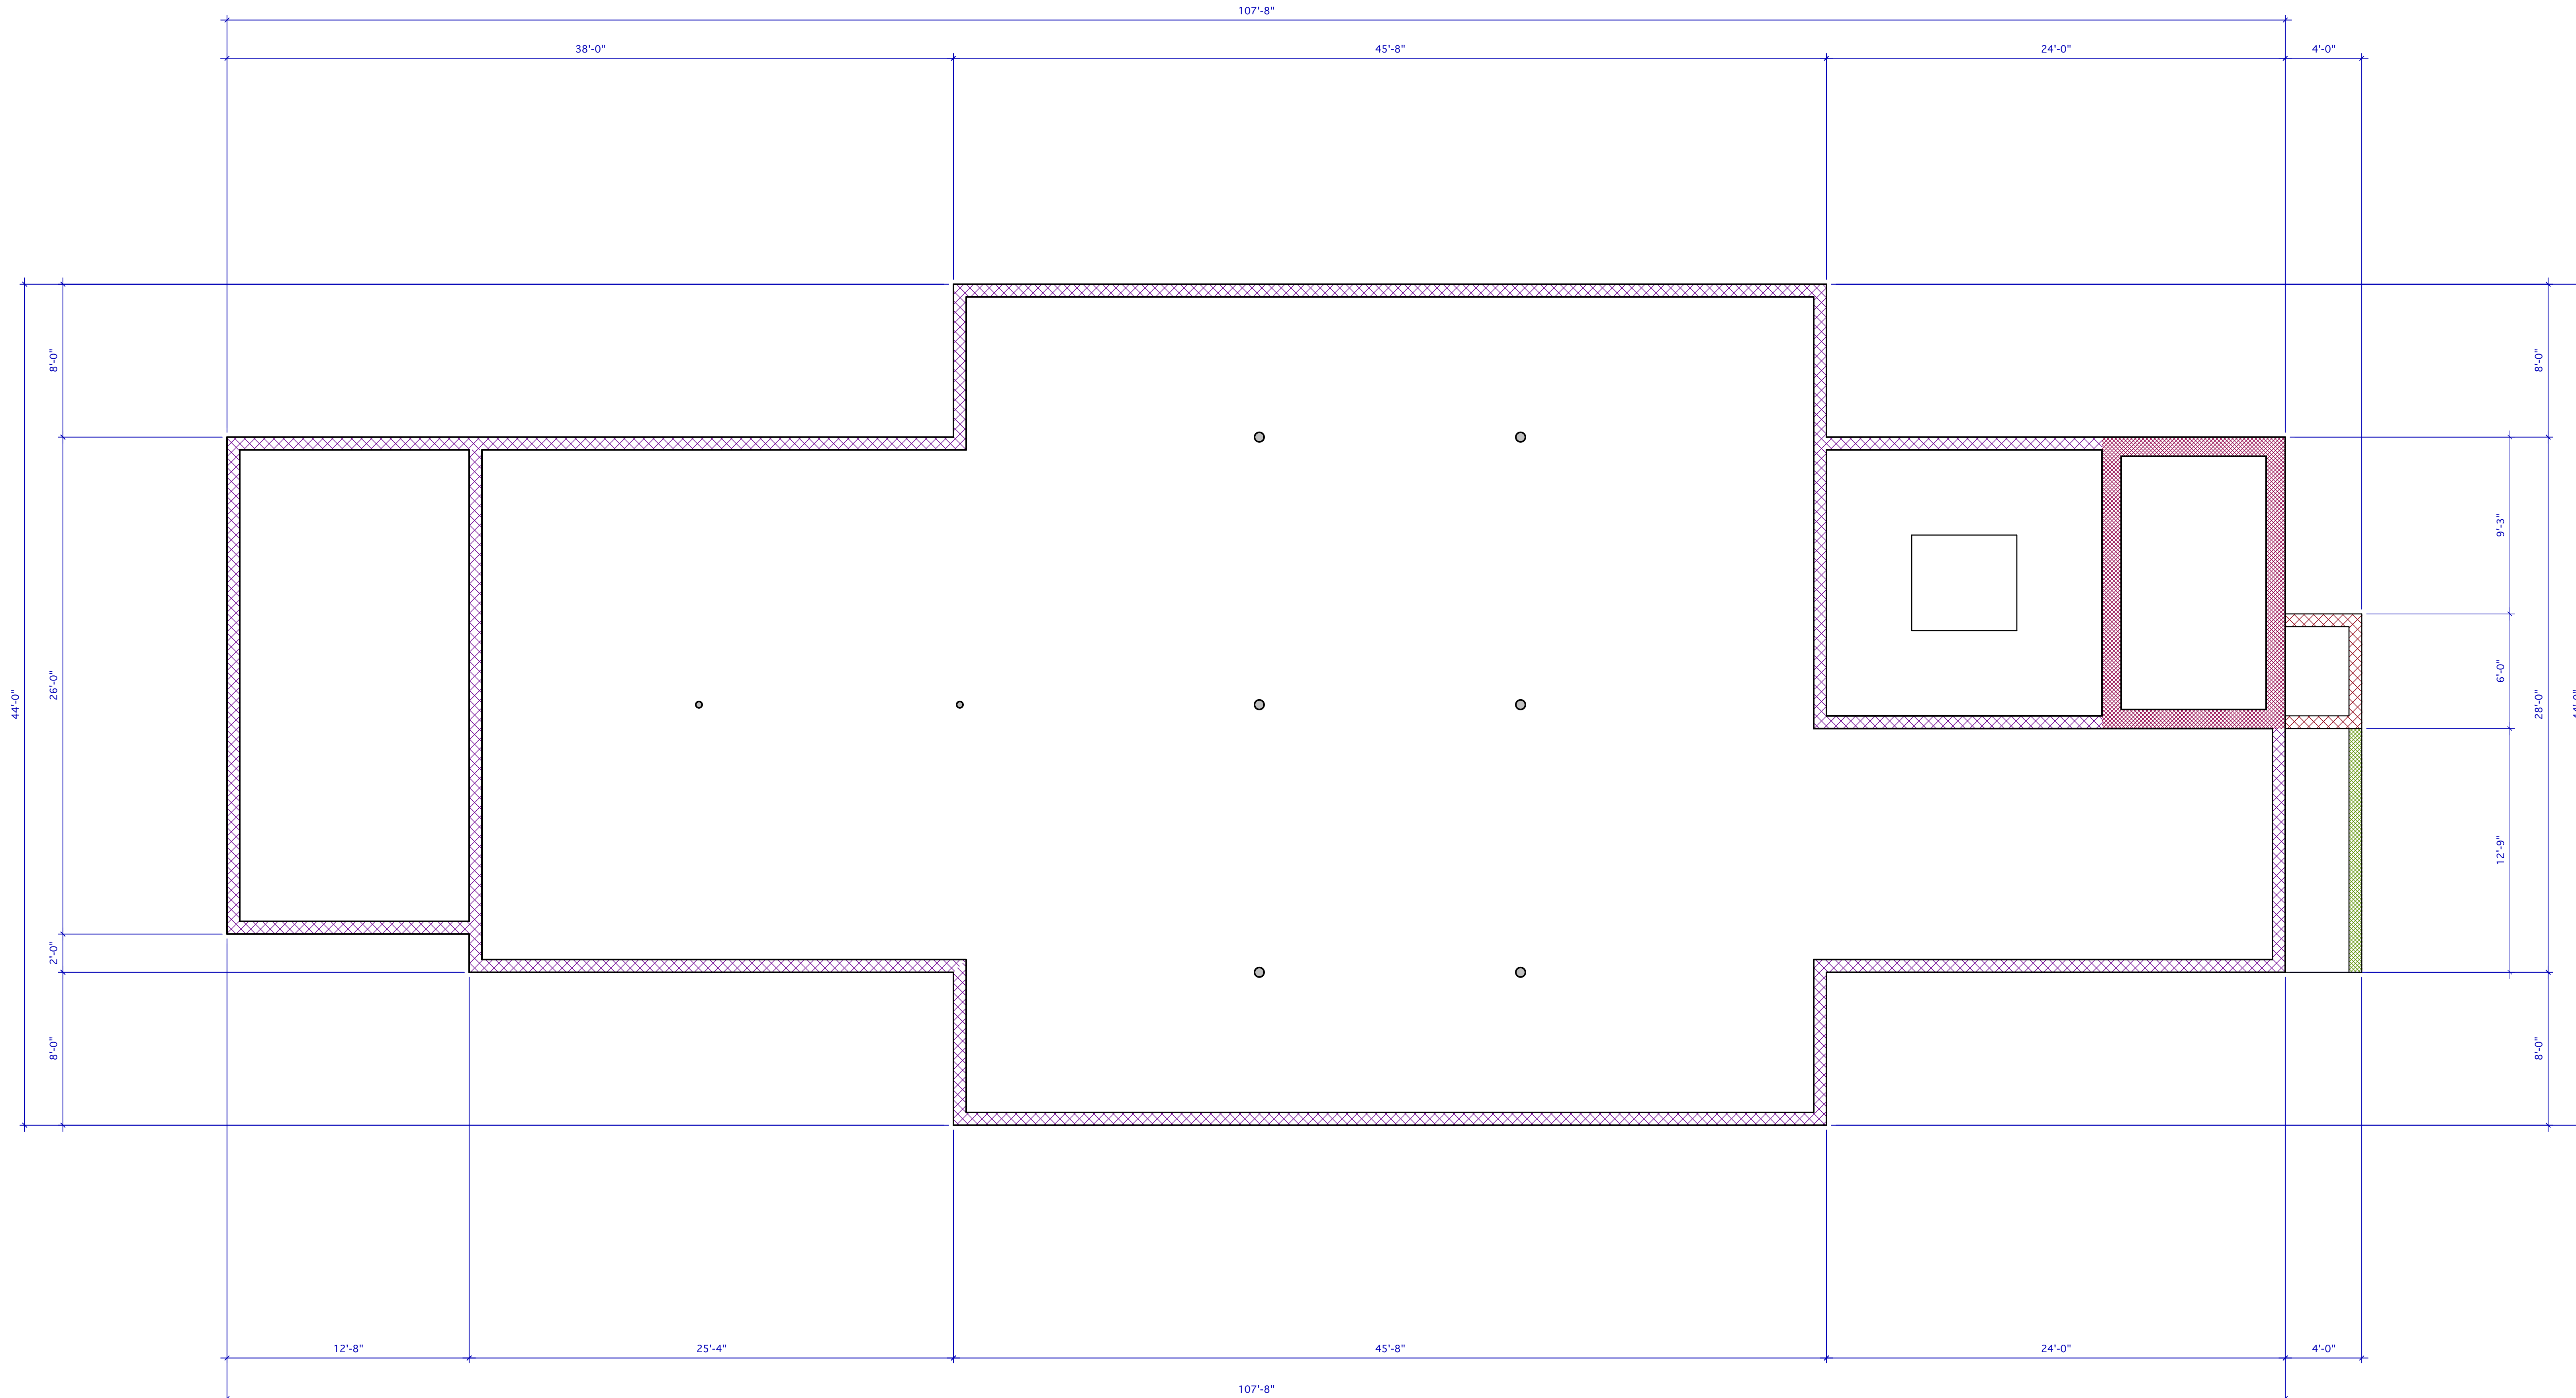
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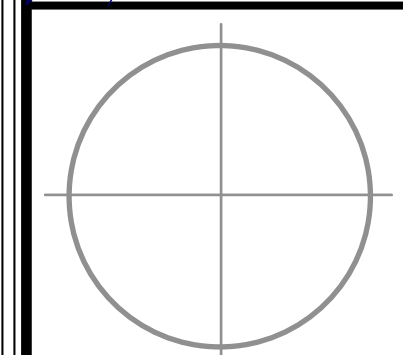
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FOUNDATION PLAN

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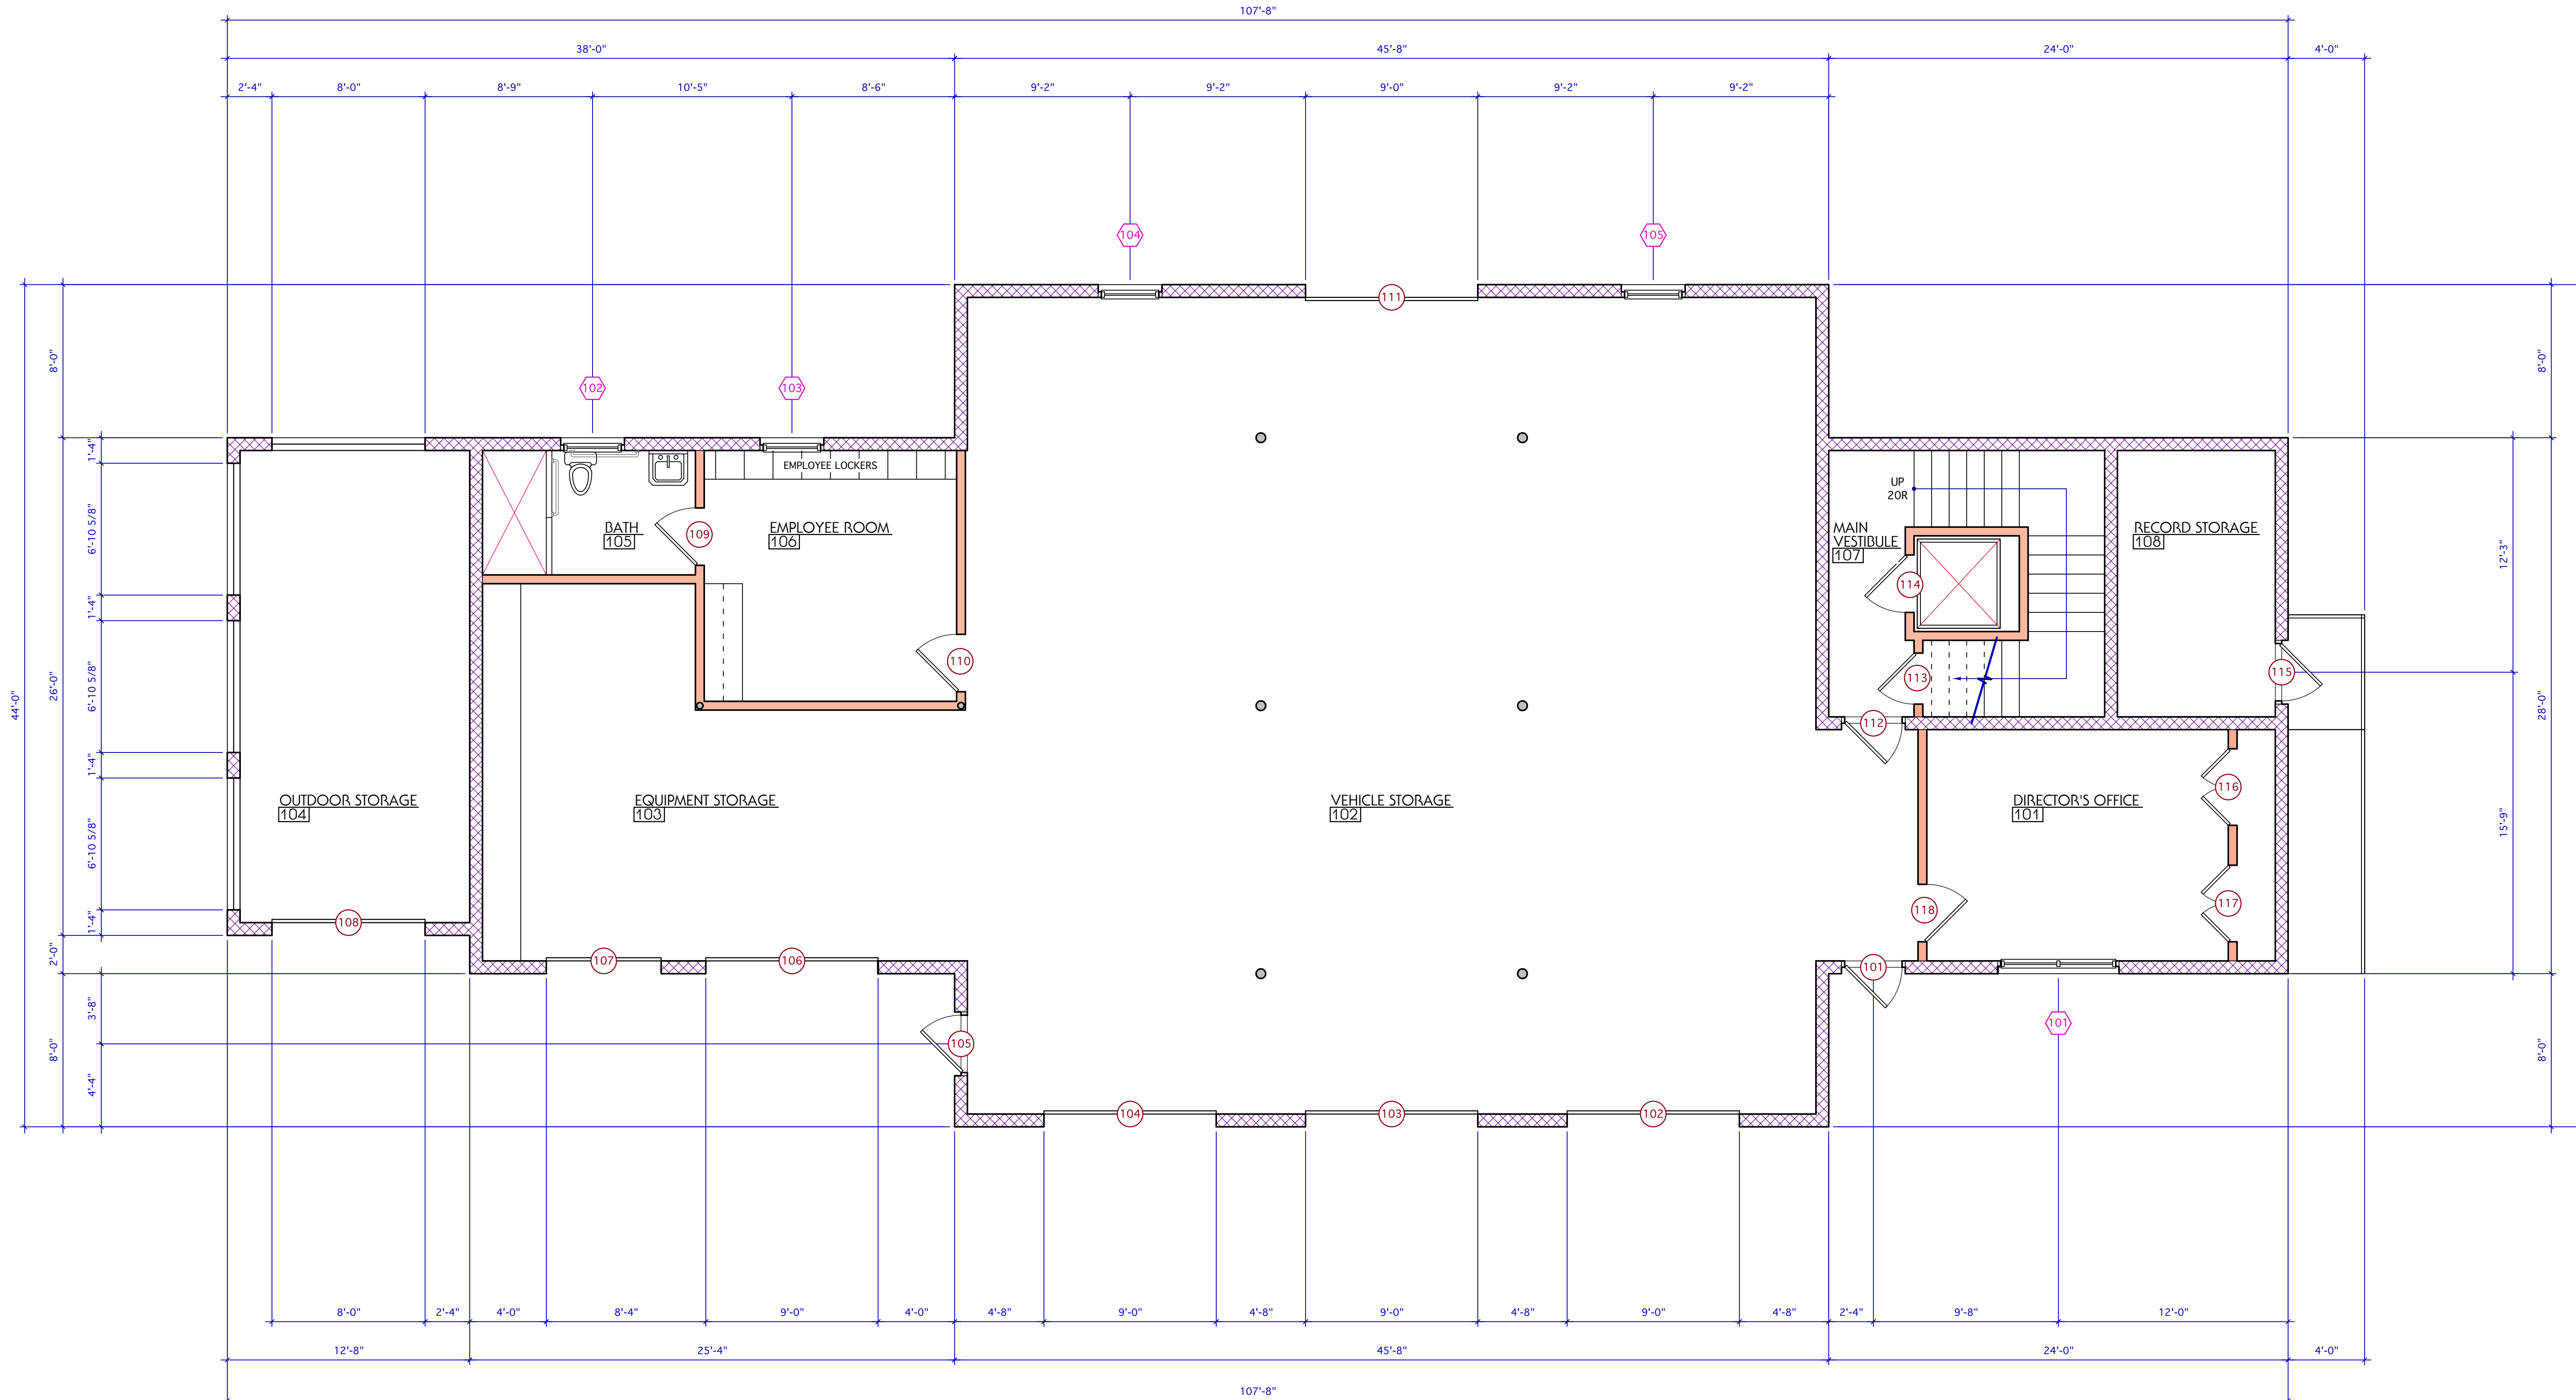
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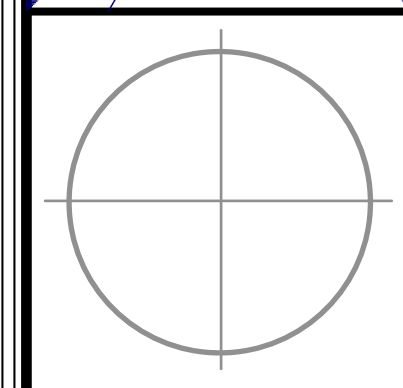
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MAIN FLOOR PLAN

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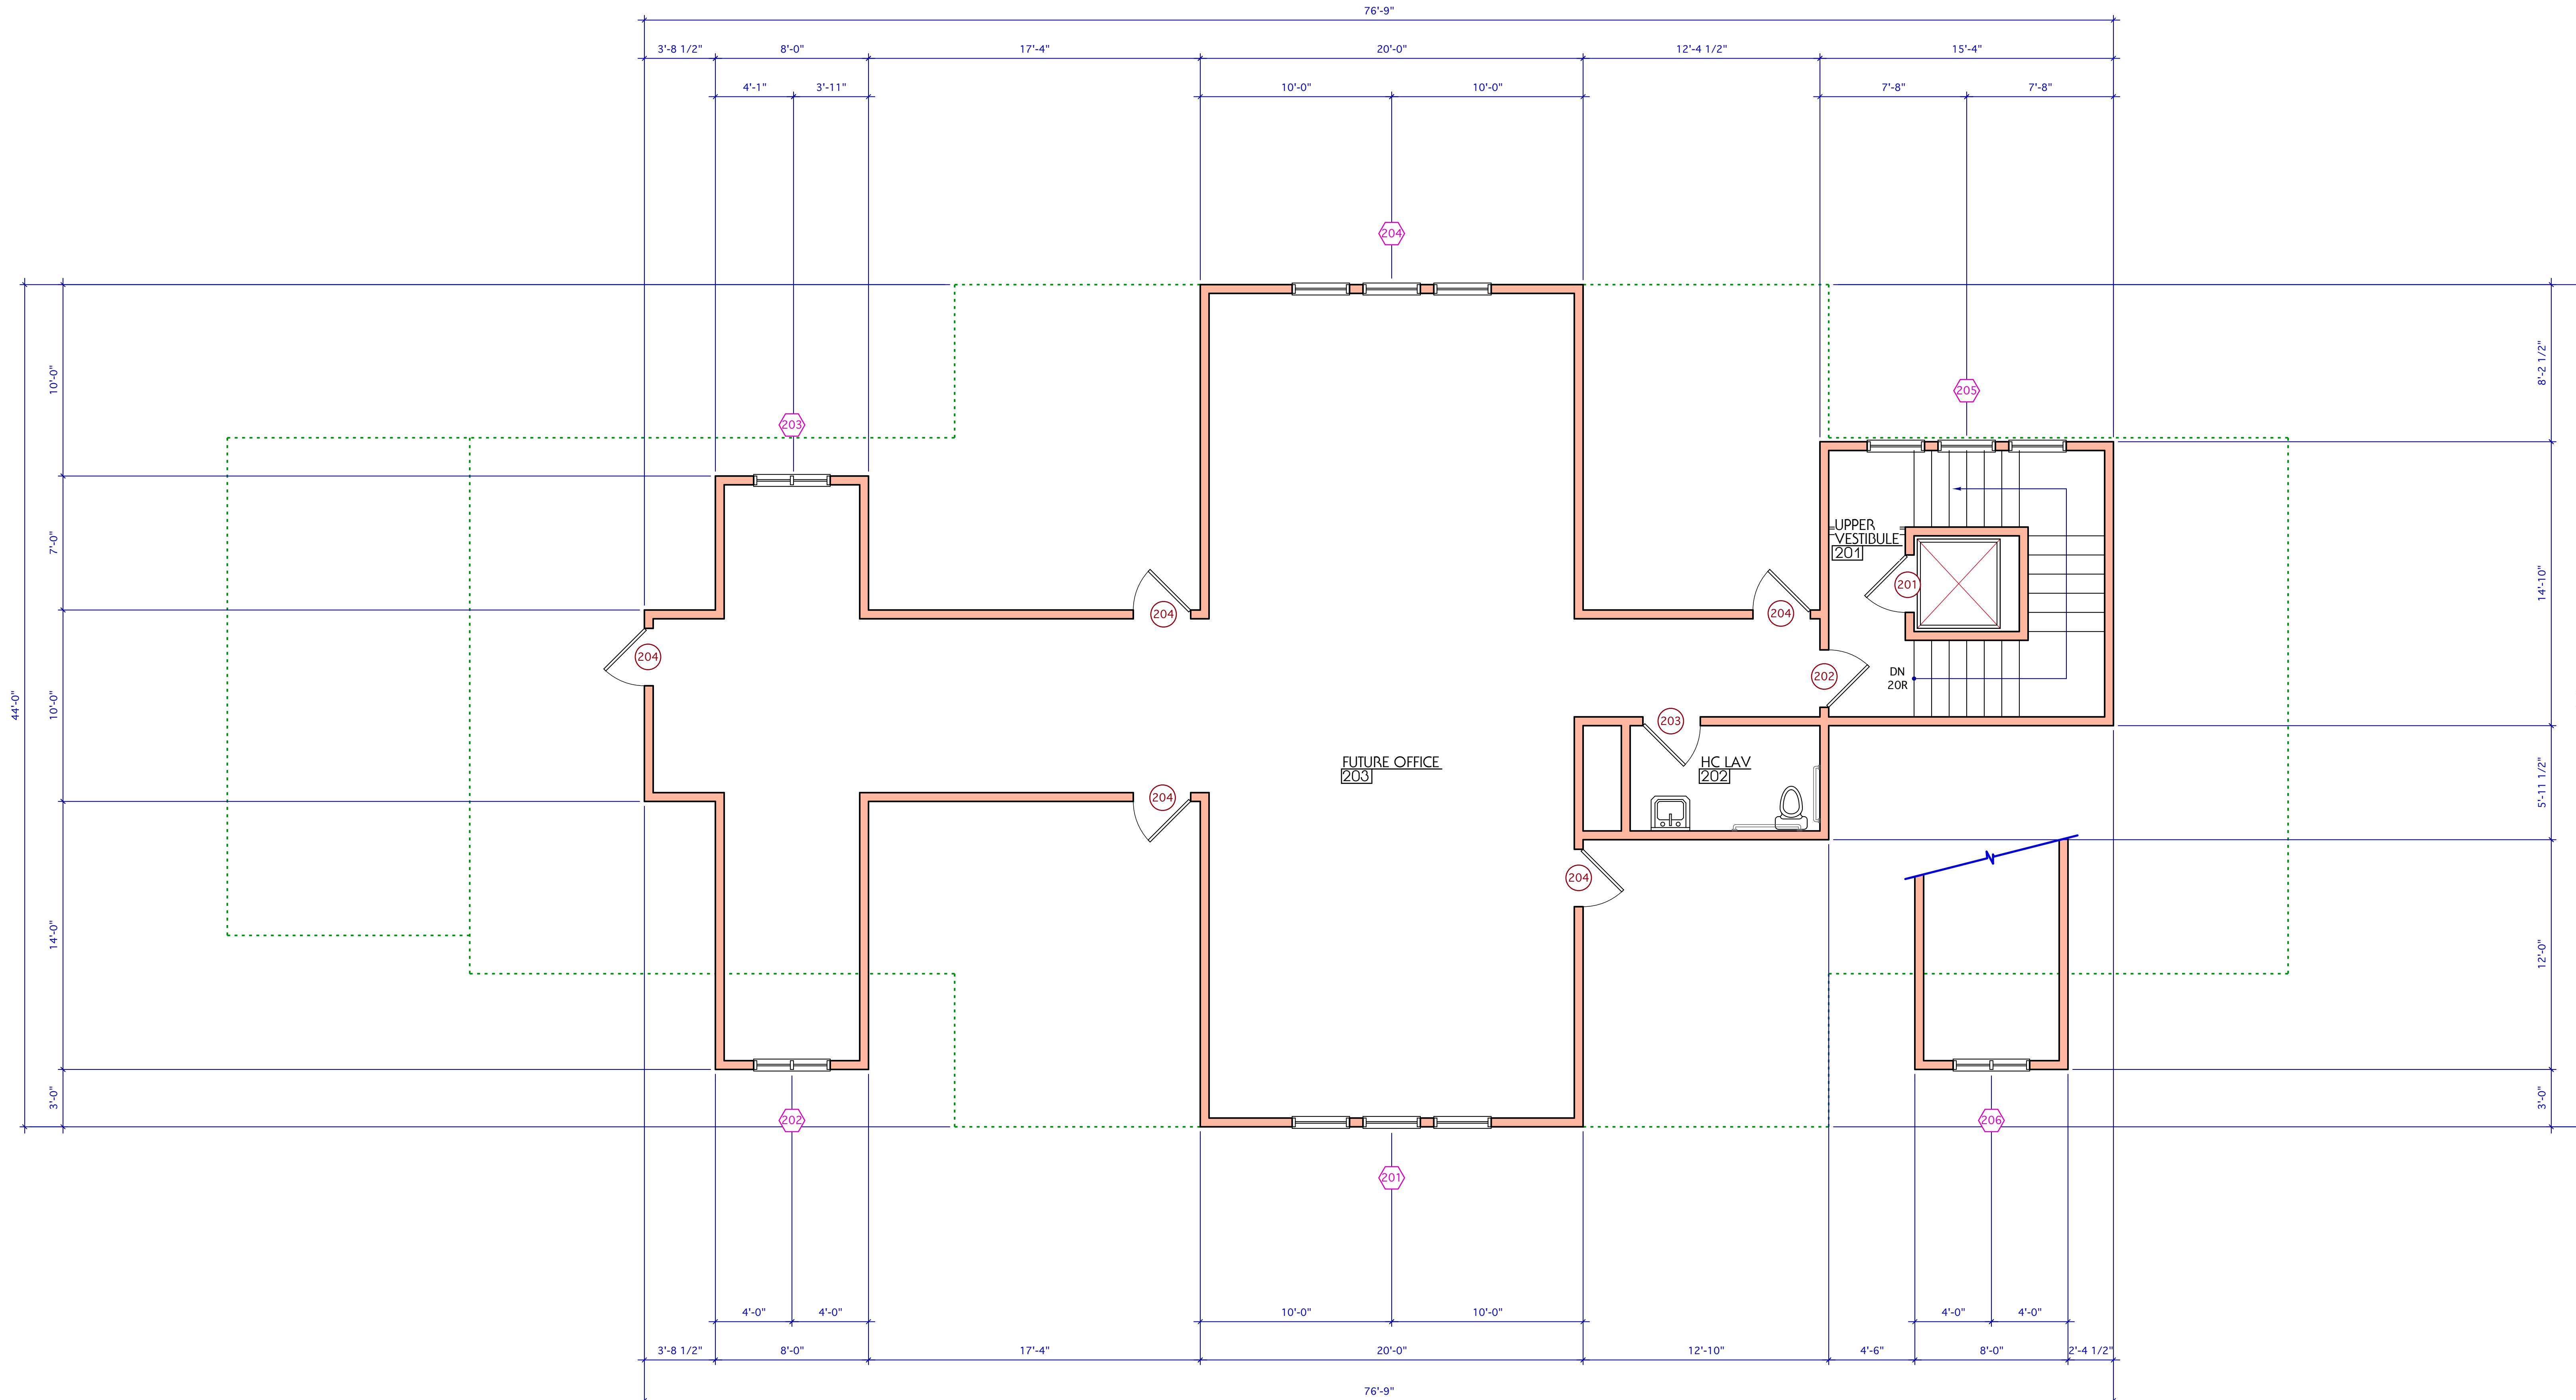
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Commission No.: SC 2216G **A1.2**
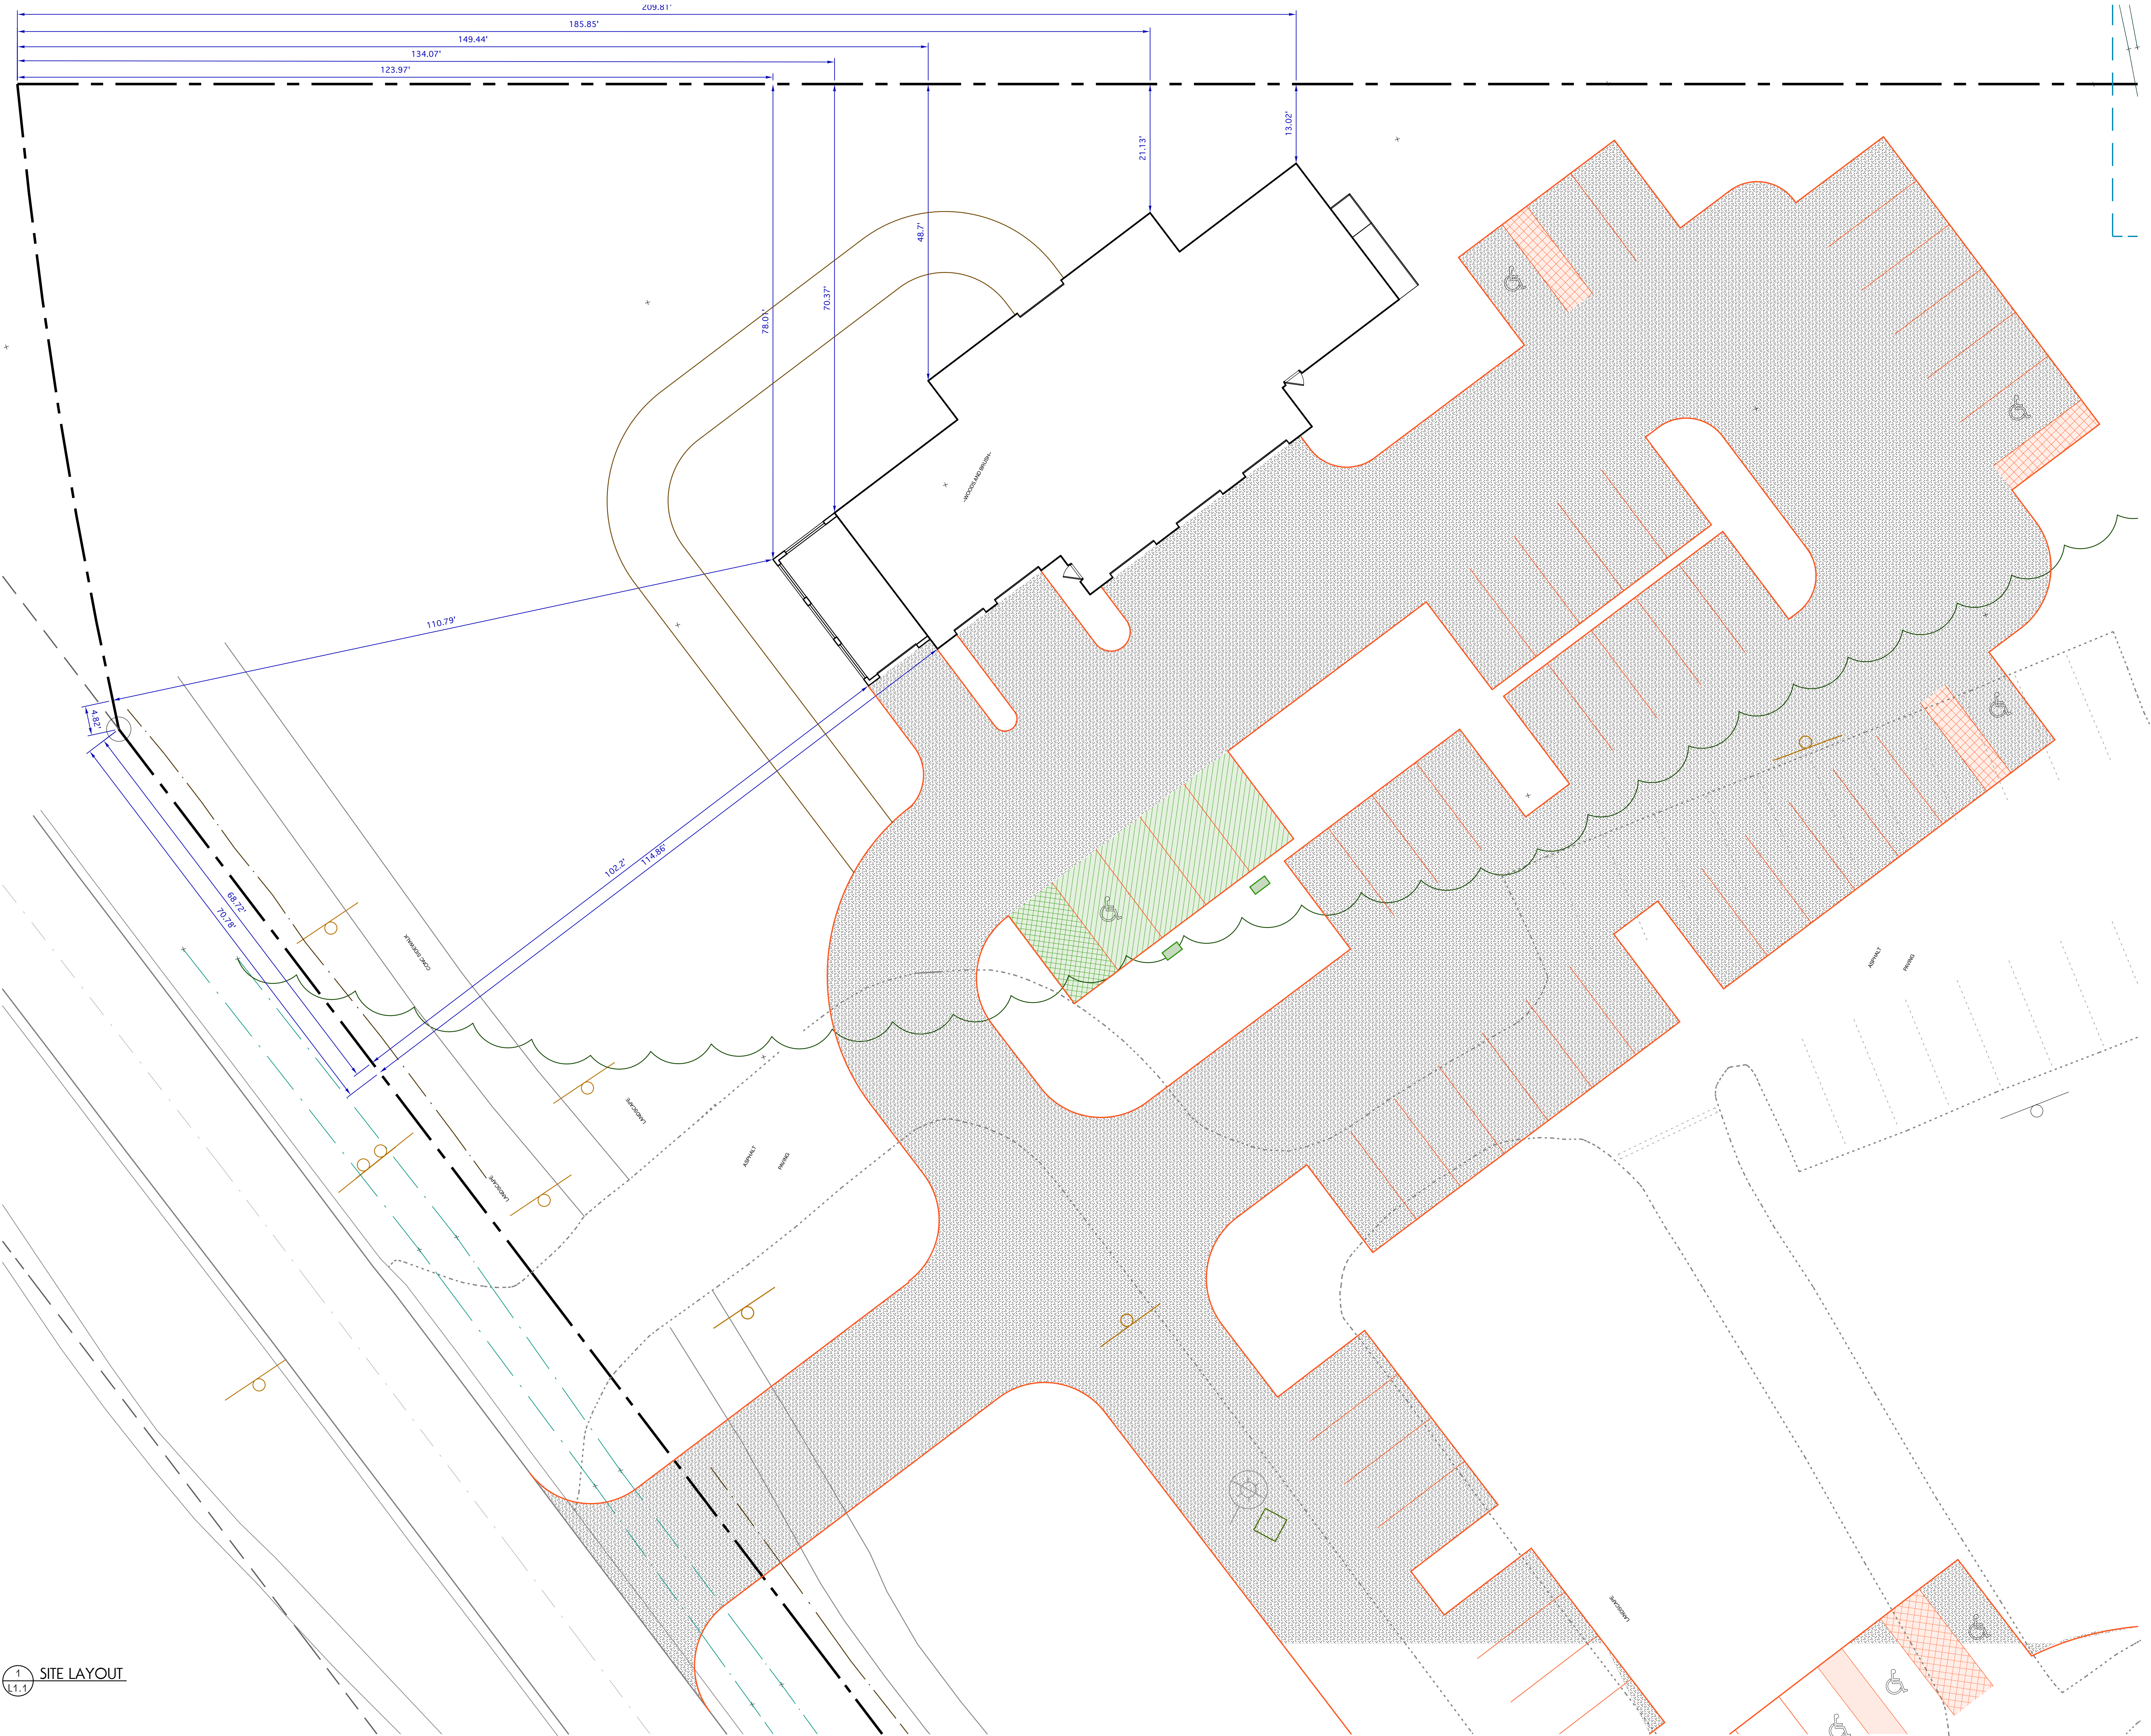
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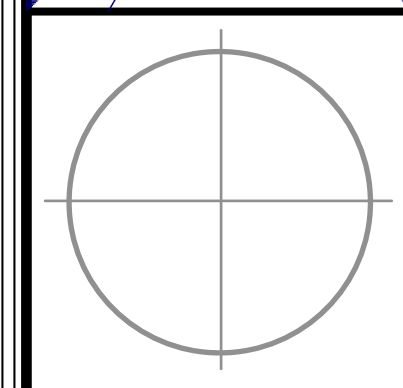
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UPPER FLOOR PLAN

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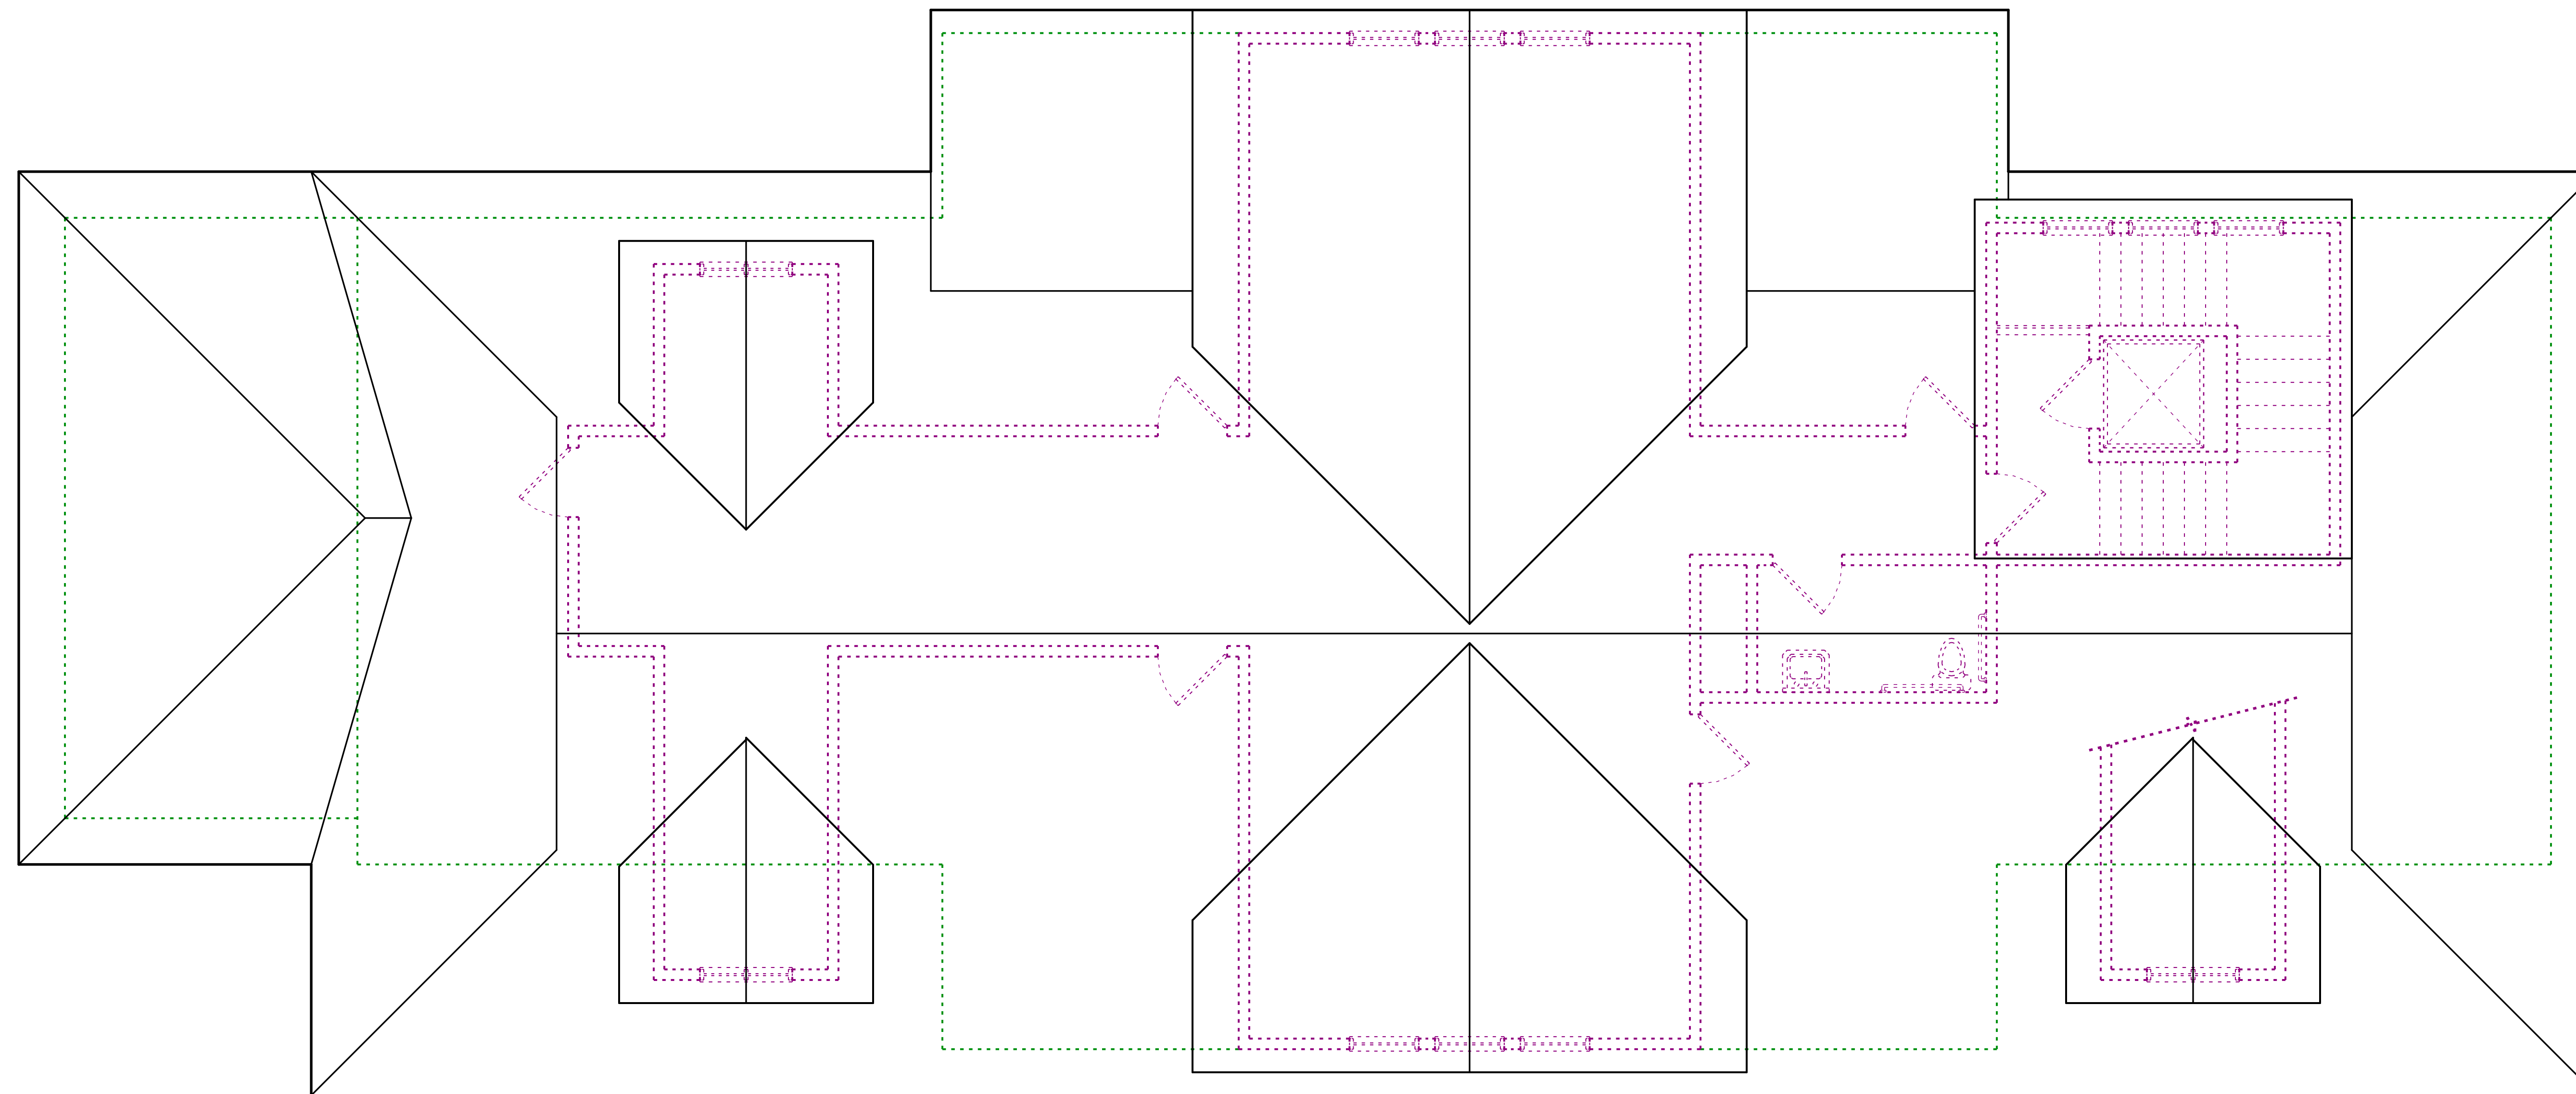
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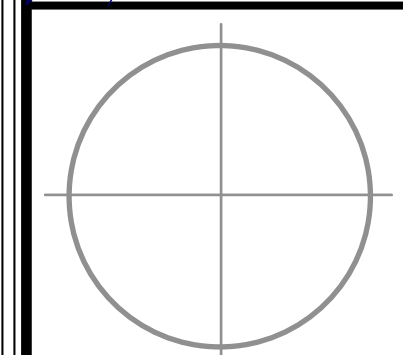
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ROOF PLAN

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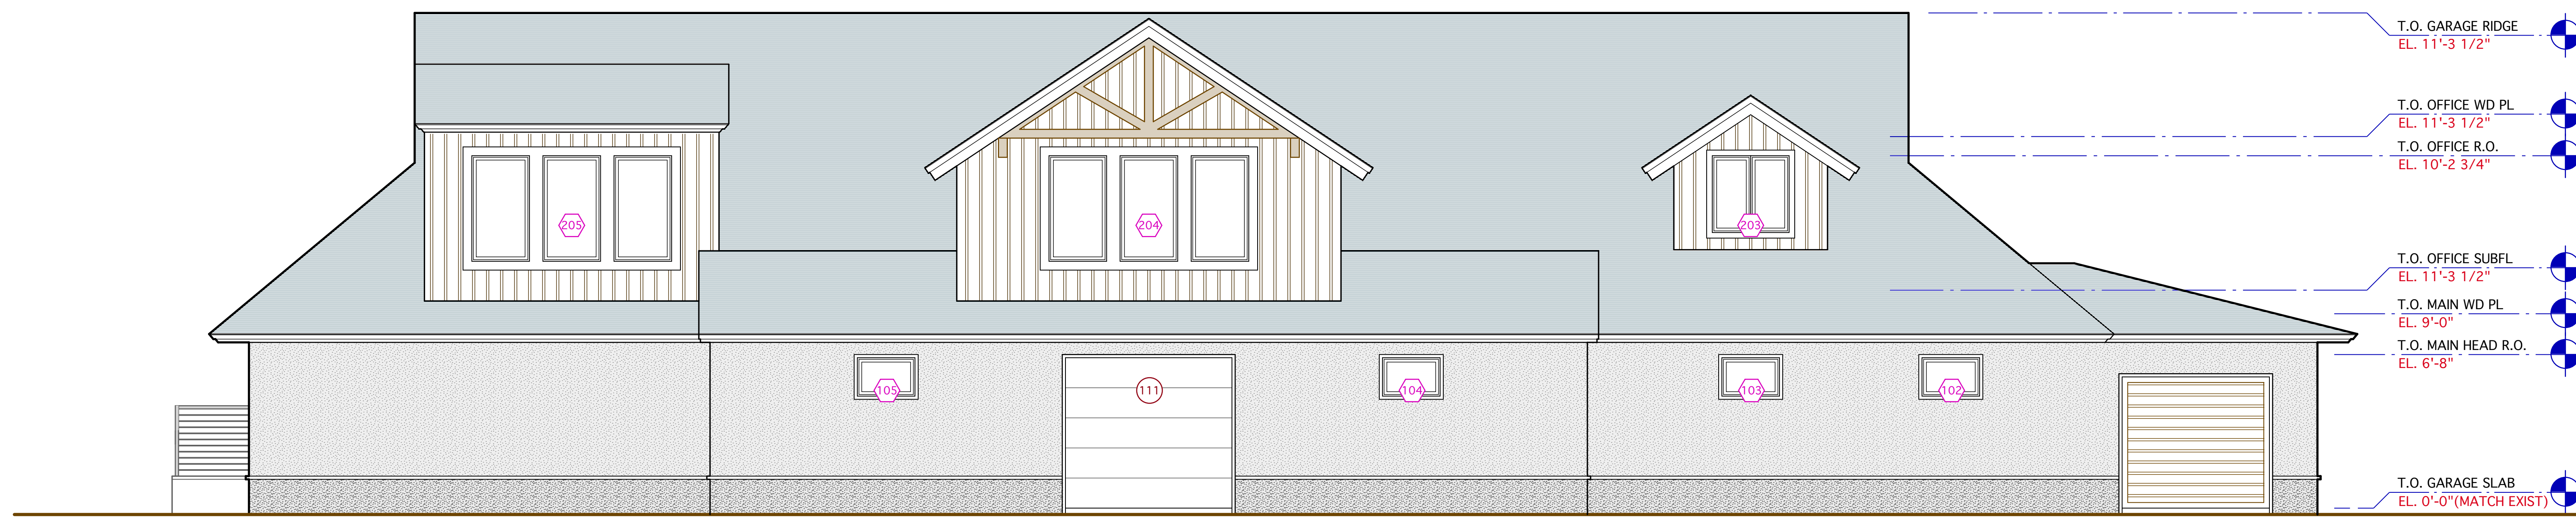
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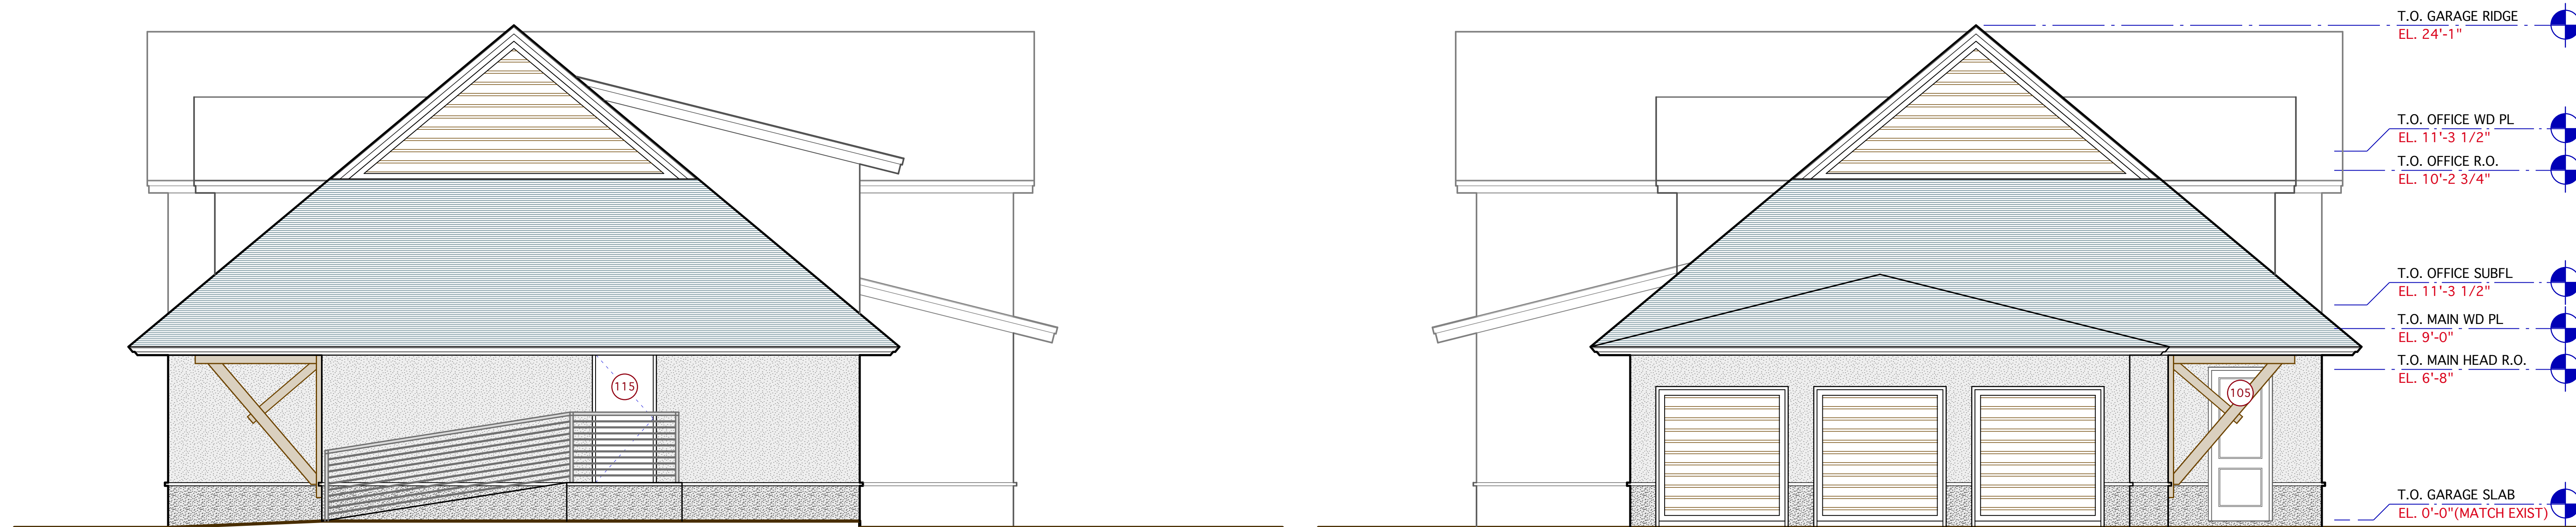
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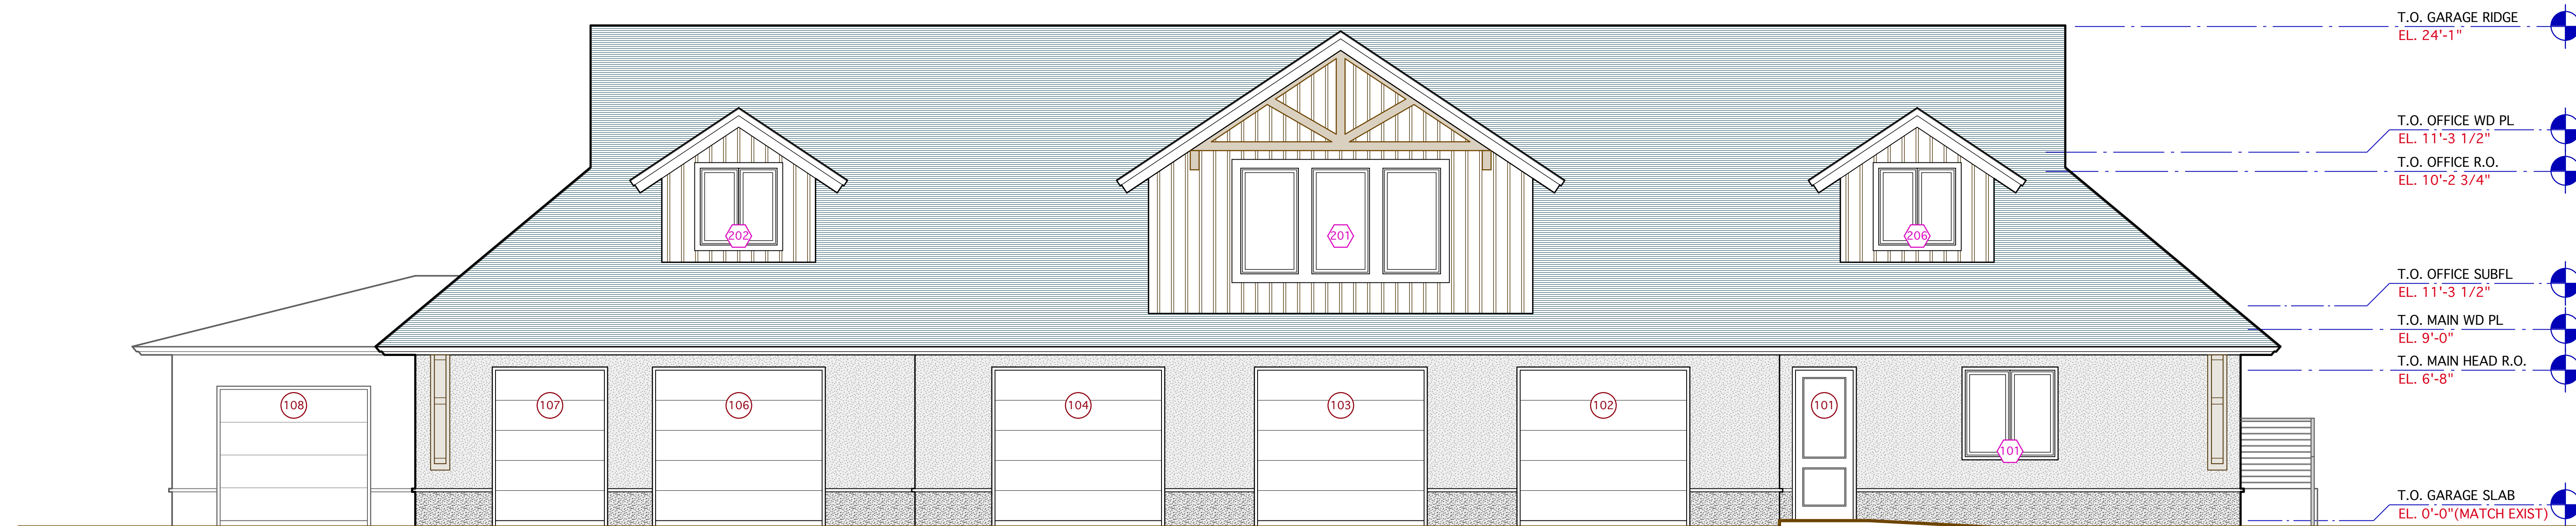


4 REAR ELEVATION
A2.1



2 LEFT SIDE ELEVATION
A2.1


3 RIGHT SIDE ELEVATION
A2.1



1 FRONT ELEVATION
A2.1

EXTERIOR ELEVATIONS

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Johns Island, SC 29457

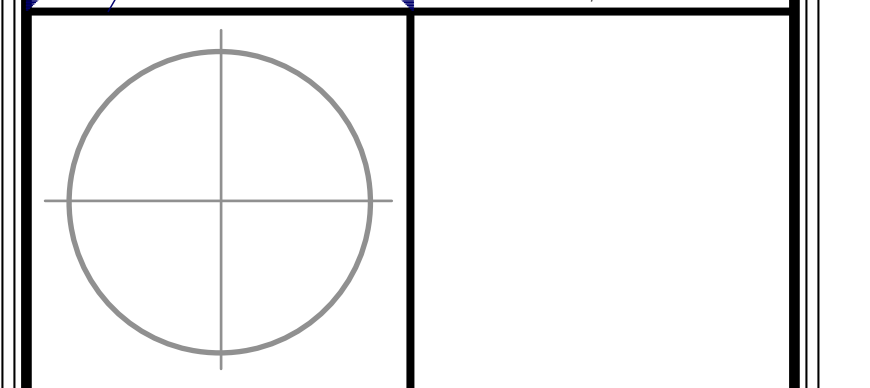

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Scale: 1/4"=1'-0"	Drawn: MK	Checked: MK
Date: MARCH 23, 2023	Drawing No.: A2.1	
Commission No.: SC 2216G		

D O O R S C H E D U L E

ALL EXTERIOR DOOR UNITS TO BE FURNISHED WITH IMPACT RESISTANT GLAZING PER 2021 IBC

DOOR	DOOR				FRAME		THRESHOLD	SCREEN	DETAILS			REMARKS
	WIDTH	HEIGHT	THICKNESS	TYPE	MAT/FINISH	THICKNESS			MAT/FINISH	TYPE	HEAD	
101	3' - 0"	8' - 0"	1 3/4"	A	FIBGL / PT							INSUL FIBERGL W/ LITES
102	9' - 0"	8' - 0"		B	MET / PT	5/4"						INSUL METAL OH GARAGE
103	9' - 0"	8' - 0"		B	MET / PT	5/4"						INSUL METAL OH GARAGE
104	9' - 0"	8' - 0"		B	MET / PT							INSUL METAL OH GARAGE
105	3' - 0"	8' - 0"	1 3/4"	A	FIBGL / PT	5/4"						
106	9' - 0"	8' - 0"		B	MET / PT							INSUL METAL OH GARAGE
107	6' - 0"	8' - 0"		B	MET / PT	5/4"						INSUL METAL OH GARAGE
108	9' - 0"	7' - 0"		C	MET / PT	5/4"						METAL OH GARAGE
109	3' - 0"	8' - 0"	1 3/4"	D	FIBGL / PT	5/4"						
110	3' - 0"	8' - 0"	1 3/4"	D	FIBGL / PT	5/4"						
111	9' - 0"	8' - 0"		B	MET / PT	5/4"						INSUL METAL OH GARAGE
112	3' - 0"	8' - 0"	1 3/4"	D	FIBGL / PT							
113	2' - 8"	8' - 0"	1 3/4"	D	FIBGL / PT	5/4"		WOOD				
114	3' - 0"	8' - 0"	1 3/4"	D	FIBGL / PT	3/4"						RATED ELEVATOR DOOR
115	3' - 0"	8' - 0"	1 3/4"	E	MET / PT	3/4"						FLUSH INSUL METAL
116	2-2' - 0"	8' - 0"	1 3/4"	D	FIBGL / PT	3/4"						
117	2-2' - 0"	8' - 0"	1 3/4"	D	FIBGL / PT	3/4"		MARBLE				
118	3' - 0"	8' - 0"	1 3/4"	D	FIBGL / PT	3/4"						
201	3' - 0"	7' - 0"	1 3/4"	F	MDF/PT	3/4"						RATED ELEVATOR DOOR
202	3' - 0"	7' - 0"	1 3/8"	F	MDF/PT	3/4"						
203	3' - 0"	7' - 0"	1 3/8"	F	MDF/PT	3/4"						
204	3' - 0"	7' - 0"	1 3/4"	F	MDF/PT	3/4"						WEATHERTITE ATTIC ACCESS DOOR

W I N D O W S C H E D U L E

ALL WINDOW UNITS TO BE FURNISHED WITH IMPACT RESISTANT GLAZING PER 2021 IBC

NO.	TYPE	ROUGH OPENING		LITE CUT	MANUFACTURER	PRODUCT	SCREEN	JAMB	DETAILS			REMARKS
		WIDTH	HEIGHT						HEAD	JAMB	SILL	
101	A	4' - 9"	4' - 6"	1/1	ANDERSEN	CW245	✓	6 11/16"	CH1	CJ1	CS1	PAIR CLAD CASEMENT
102	B	3' - 0"	2' - 0"	1/1	ANDERSEN	A31	✓	6 11/16"	CH1	CJ1	CS1	CLAD AWNING
103	B	3' - 0"	2' - 0"	1/1	ANDERSEN	A31	✓	6 11/16"	CH1	CJ1	CS1	CLAD AWNING
104	B	3' - 0"	2' - 0"	1/1	ANDERSEN	A31	✓	6 11/16"	CH1	CJ1	CS1	CLAD AWNING
105	B	3' - 0"	2' - 0"	1/1	ANDERSEN	A31	✓	6 11/16"	CH1	CJ1	CS1	CLAD AWNING
201	C	9' - 4"	5' - 6"	1/1	ANDERSEN	CX155	✓	6 11/16"	CH1	CJ1	CS1	TRIPLE CLAD CASEMENT (8" MULL)
202	D	4' - 0"	4' - 0"	1/1	ANDERSEN	C24	✓	6 11/16"	CH1	CJ1	CS1	PAIR CLAD CASEMENT
203	D	4' - 0"	4' - 0"	1/1	ANDERSEN	C24	✓	6 11/16"	CH1	CJ1	CS1	PAIR CLAD CASEMENT
204	C	9' - 4"	5' - 6"	1/1	ANDERSEN	CX155	✓	6 11/16"	CH1	CJ1	CS1	TRIPLE CLAD CASEMENT (8" MULL)
205	C	9' - 4"	5' - 6"	1/1	ANDERSEN	CX155		6 11/16"	CH1	CJ1	CS1	TRIPLE CLAD CASEMENT (8" MULL)
206	D	4' - 0"	4' - 0"	1/1	ANDERSEN	C24	✓	6 11/16"	CH1	CJ1	CS1	PAIR CLAD CASEMENT

R O O M F I N I S H S C H E D U L E

RM #	NAME	FLOOR		BASE/TRIM TYPE		WALLS - MATERIAL / FINISH		CEILING			REMARKS
		MATERIAL	FINISH	TYPE	MAT/FINISH	CASING	HEIGHT	MAT/FINISH	CROWN		
101	DIRECTOR'S OFFICE	CONC	BRICK			CEMENTITIOUS SIDING - PAINT		10'-4"	WOOD - NAT	B	EXTERIOR SPACE
102	VEHICLE STORAGE	PLYWD	BRICK	C	WD. - PAINT	GYP. BD. - PAINT		B	VARIES	GYP. BD. - PT.	C
103	VEHICLE SHOP	WOOD	NAT	C	WD. - PAINT	M. R. GYP. BD. - PAINT		B	10'-0"	GYP. BD. - PT.	C
104	OUTDOOR STORAGE	WOOD	NAT	C	WD. - PAINT	GYP. BD. - PAINT		B	10'-0"	GYP. BD. - PT.	C
105	BATH	WOOD	NAT	B	WD. - PAINT	M. R. GYP. BD. - PAINT		C	9'-0"	GYP. BD. - PT.	D
106	EMPLOYEE ROOM	WOOD	NAT	B	WD. - PAINT	M. R. GYP. BD. - PAINT		C	10'-0"	GYP. BD. - PT.	D
107	MAIN VESTIBULE	WOOD	NAT	C	WD. - PAINT	GYP. BD. - PAINT		B	10'-0"	GYP. BD. - PT.	C
108	RECORD STORAGE	PLYWD	STONE	C/B	WD. - PAINT	M. R. GYP. BD. - PAINT		B/C	10'-0"	GYP. BD. - PT.	C/D
201	UPPER VESTIBULE	WOOD	NAT	C	WD. - PAINT	GYP. BD. - PAINT		B	VARIES	GYP. BD. - PT.	D
202	FUTURE LAV	PLYWD	STONE	C	WD. - PAINT	M. R. GYP. BD. - PAINT		B	10'-0"	GYP. BD. - PT.	D
203	FUTURE OFFICE	WOOD	NAT	C	WD. - PAINT	WD / GYP. BD. - PAINT		B	10'-0"	GYP. BD. - PT.	C


Seabrook Municipal Maintenance Facility

Town of Seabrook Island
2001 Seabrook Island Rd
Seabrook Island, SC

Revisions:

DOOR SCHEDULE

MICHAEL E. KARAMUS ARCHITECT, L.L.C.
P. O. Box 206
Johns Island, SC 29457

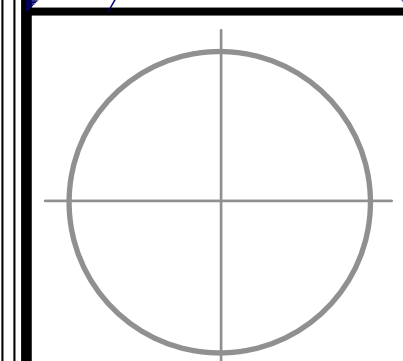

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Scale:	AS NOTED	Drawn:	Checked:
		MK	MK

Date:	Drawing No.:
MARCH 23, 2023	

Commission No.:	A7.1
SC 2216G	



SafePace[®] Evolution 12FM




The SafePace Evolution 12FM variable message sign is a compact, portable solution offering adjustable driver-responsive messages.

The compact yet robust Traffic Logix SafePace Evolution 12FM offers the flexible, customizable messaging options you'd expect from a larger sign. The sign includes a full matrix for text, graphics, or 12" speed display, including speed activated digit color changes and choice of messaging color. The Evolution 12FM sign is the sign with a small footprint yet wide range of messaging options.



EV 12FM Specifications	
Digit Size	12"
Height	29"
Weight	20 lbs
24/7, 365 Scheduling	✓
Data Collection	✓
Solar Compatibility	✓
Battery Operated	✓
Universal Mounting	✓
Cloud Compatibility	✓
Trailer Compatibility	✓
Dolly Compatibility	✓
Hitch Compatibility	✓
Warranty	2 Years

Features
Compact design offers all the features and visibility you'd expect from a full size variable message sign.
Allows for animated text or graphics such as moving arrows or a scrolling message.
Universal Mounting: Optional mounting brackets let you use one sign at multiple locations with the turn of a key.
Dual-Color Display: Display color can be programmed to change based on driver speed.
Ultra-low power consumption including the most power-efficient radar technology available and optional solar power.
Includes integrated flashing speed violator strobe to alert speeding drivers.
Stealth Mode allows the sign to collect baseline traffic data while speed display appears blank to motorists.

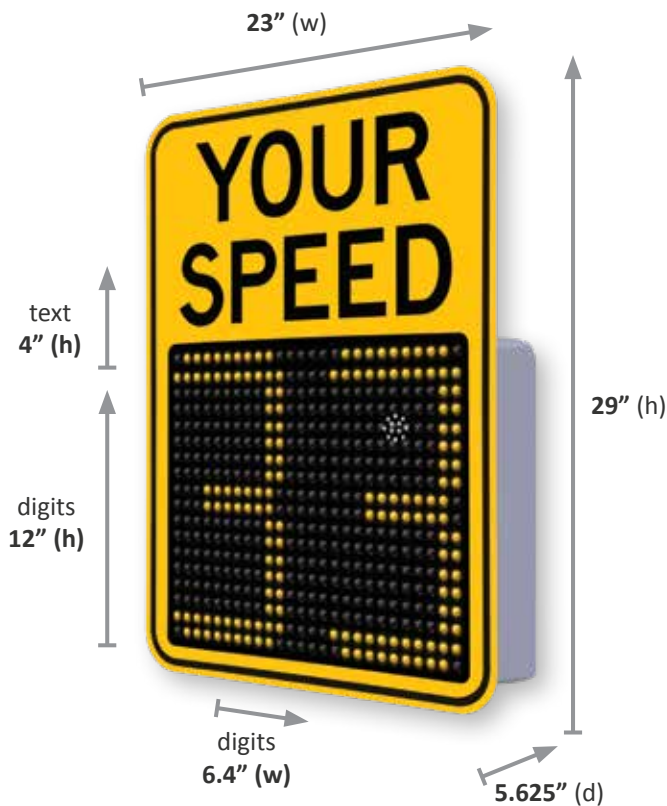

Feature	Specifications
Dimensions	
Digits	12"(h) x 6.4"(w), 936 LEDs
Variable Message Matrix mode	13"(h) x 18.25"(w), 936 LEDs
Unit with "YOUR SPEED" sign mounted	Full size sign: 29.0"(h) x 23.0"(w) x 5.625"(d)
Sign Weight (includes "YOUR SPEED" sign (2 lbs) mounted)	
AC Powered	20 lbs
Battery Powered Model	20 lbs (not including batteries)
Solar powered model	20 lbs (does not include batteries, solar panel or bracket)
General Specifications	
Operating Temperatures F (C):	-40° (-40°) to 185° (85°)
3-Digit Speed Display	Miles Per Hour (mph): 3-99 mph Kilometers Per Hour (km/h): 5-160 km/h
Faceplate	High-Intensity prismatic reflective sheeting on "YOUR SPEED" signs with black colored text. MUTCD approved colors and format
Communications	Bluetooth, GSM/GPRS
Programming	SafePace® Pro management software SafePace® Cloud remote management 24/7 365 day unlimited programming and scheduling
Power Options (Electrical Specifications)	
AC power input	100-240 V AC

Feature	Specifications
DC power input	12 V DC
Solar panel options	50W or 90W solar panel
Radar	
Internal Radar:	Doppler (FCC approved)
Model	DF 600
Radar RF out	5 mW maximum
Radar f-center	24.125 GHz or 24.200 GHz
Pickup distance	Up to 400 feet
Beam angle	24° (vertical) x 12° (horizontal)
Beam polarization	Linear
CE Mark (Radar)	Yes
Display	
LEDs	948
Digits	468 LEDs: Color: Yellow (590 nm) Viewing angle at 50% IV: 30° Partial Flux (Brightness): 9000 – 22400 Ev,[lux]/LED 468 LEDs: Color: Red (633 nm) Viewing angle at 50% IV: 30° Partial Flux (Brightness): 7100 – 18000 Ev,[lux]/LED
Speed Violator Strobe	12 LEDs: Color: White (2700 K – 6500 K) Viewing angle at 50% IV: 150° Luminous Flux: typically 33lm @ 4000 K Luminous Efficacy: typically 176 lm/W @4000 K
Ambient light sensor	1 sensor and automatic brightness adjustment
Characters	Max Lines of text = 2 Max height of text = 5" Max characters/line= 4
Enclosure	
Construction	Vandal resistant, lightweight polymer. Matte black front for reduced glare and maximum contrast. Light gray body to minimize heat absorption
Weatherproof Rating	Weatherproof, NEMA 4X-12, IP65 level compliant. Non-sealed and ventilated
Warranty	
Sign	2 years
Batteries	1 year

Distributed by
AC power input



1-800-236-0112
www.tapconet.com



Contract Holder
GS-07F-5924R
GS-07F-0234U



13W TOP-OF-POLE SELF-CONTAINED SOLAR CABINET

FEATURES AND BENEFITS


Uniquely designed using durable polycarbonate, TAPCO's new 13-Watt Top-Of-Pole Self-Contained Solar Cabinet is a lightweight option that powers a wide range of traffic-calming devices.

- Up to 28Ah of battery power delivers autonomy up to 30 days
- Slim, contoured design and black finish blends into surrounding environment
- Supports active and passive detection devices
- Universal mounting bracket mounts to any pole type



SPECIFICATIONS

HOUSING	Polycarbonate
SOLAR PANEL	13W
BATTERY CAPACITY	6V, 28Ah
BATTERY LIFESPAN	3 to 5 years, field replaceable
MOUNTING OPTIONS	Various sizes of poles and posts
MOUNTING HARDWARE	Universal mounting bracket included
WEIGHT	10 pounds
OPERATING TEMPERATURE RANGE	-40°F to 122°F (-40°C to 50°C)
WARRANTY	3-year limited battery warranty 5-year limited system warranty 10-year limited solar panel warranty

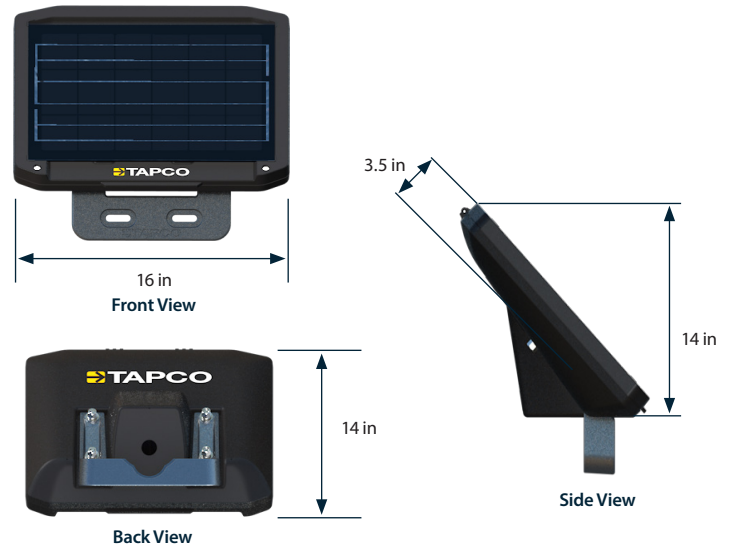



SYSTEM CAPABILITIES

FLASH PATTERN	MUTCD section 2A.07 compliant options (Interim Approval 21 compliant WW + S for RRFB)
DIMMING	6V solar panel input through TAPCO controller
WIND LOAD RATING	Up to 120mph*

*Dependent upon pole size and system arrangement

BLINKERBEAM® WIRELESS COMMUNICATION

FREQUENCY	900 MHz FHSS (Frequency Hopping Spread Spectrum)
RANGE	900 feet (radio site survey recommended)
CONNECTIVITY	Crosswalk and optional advance warning LEDs activate concurrently

SYSTEM ACTIVATIONS

PUSH BUTTON ACTIVATION	ADA push button, typical (<120 millisecond)
USER-ACTUATED PUSH BUTTON	Bulldog 300, 20-second daily activations
PASSIVE DETECTION	Radar
AUTONOMY	Up to 30 days with 28Ah battery power

(800) 236-0112

TAPCOnet.com



Safe travels:

Traffic and Parking Control Co., Inc.
5100 West Brown Deer Rd
Brown Deer, WI 53223
Phone No.:800-236-0112
E-Mail: info@tapconet.com

SALES QUOTE

SALES QUOTE DATE

3/13/2023

SALES QUOTE NUMBER

Q23004049

CUSTOMER NO.

C99395

Page: 1

BILL TO

Town of Seabrook Island
Barry Goldstein
2001 Seabrook Island Rd
Seabrook Island, SC 29455-6321
United States of America

SHIP TO

Town of Seabrook Island
Barry Goldstein
2001 Seabrook Island Rd
Seabrook Island, SC 29455-6321
United States of America

SHIP VIA

BEST RATE

TERMS

Net 30 DAYS

SALESPERSON

Kyle Stewart

VALID UNTIL

4/12/2023

Item/Description	U/M	Quantity	Unit Price	Total Price
EV12 FULL MATRIX RADR FEEDBACK SIGNS:				
141792	Each	2	3,895.00	7,790.00
EV 12" Full Matrix Radar Feedback Sign, 50W Solar Panel,White HIP Face,23"x29",1 Year Cloud Service				
SOLAR, DOUBLE SIDED RRFB SYSTEM:				
600588	Each	2	4,500.00	9,000.00
PEDX, RRFB, Solar 13/28, Radio, TOP, DS, Amber, PB, H/T Pole X2				
373-05075	Each	8	98.35	786.80
W11-2,30"x30"x.080 DG3 FYG,Pedestrian Crossing (Symbol) Fed Spec - Fluorescent Yellow-Green Sign				
373-01757	Each	4	37.95	151.80
W16-7PR,24"x12"x.080 DG3 FYG,Down Diagonal Right Arrow (Fed Spec) Sign				
373-01759	Each	4	37.95	151.80
W16-7PL,24"x12"x.080 DG3 FYG,Down Diagonal Left Arrow (Fed Spec) Sign				
037-00012B	Bag	8	12.00	96.00
BB832 Double-sided sign bracket bagged Pairs for 2-3/8" round posts,raw,hangs 2 signs				
372-00001	Each	6	165.00	990.00
Pole,Round,2-3/8"OD x12'x.095 Wall Galvanized 13 Gauge,SS-20-12				
101832-10	Each	6	70.95	425.70

All prices are listed in US Dollar (USD)

For terms and conditions, please visit <https://tapconet.com/terms-conditions>



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5100 West Brown Deer Rd
Brown Deer, WI 53223
Phone No.:800-236-0112
E-Mail: info@tapconet.com

SALES QUOTE

SALES QUOTE DATE

3/13/2023

SALES QUOTE NUMBER

Q23004049

CUSTOMER NO.

C99395

Page: 2

BILL TO

Town of Seabrook Island
Barry Goldstein
2001 Seabrook Island Rd
Seabrook Island, SC 29455-6321
United States of America

SHIP TO

Town of Seabrook Island
Barry Goldstein
2001 Seabrook Island Rd
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United States of America

SHIP VIA

BEST RATE

TERMS

Net 30 DAYS

SALESPERSON

Kyle Stewart

VALID UNTIL

4/12/2023

Item/Description	U/M	Quantity	Unit Price	Total Price
V-Loc,Socket 23-VR3B				
030-00004 Bolt,Connecting Hardware,1"x4" Galvanized Bolt each w/ 1 Nut, 1 Lockwasher & 2 Flatwashers,4/Set	Set	6	33.95	203.70
109-00027 Domed Pole Cap for Round Posts FITS 2 3/8" Post	Each	2	4.00	8.00

Plus Shipping and Handling
Solar powered equipment requires no shading
or obstructions

Thank you - Kyle Stewart
#414-336-9613
Kyle.Stewart@tapconet.com

Subtotal:	19603.80
Invoice Discount:	0.00
Total Sales Tax:	0.00
Total:	19,603.80

All prices are listed in US Dollar (USD)
For terms and conditions, please visit <https://tapconet.com/terms-conditions>



V-LOC BREAKAWAY Sign Support System

The Industry Standard of Sign Anchors



Post Models for:

Round Post
Square Post
U-Channel Post


(all models come in various diameters & lengths)

Support Systems & Models for:

Single Mailbox
Double Mailboxes
Multiple Mailboxes

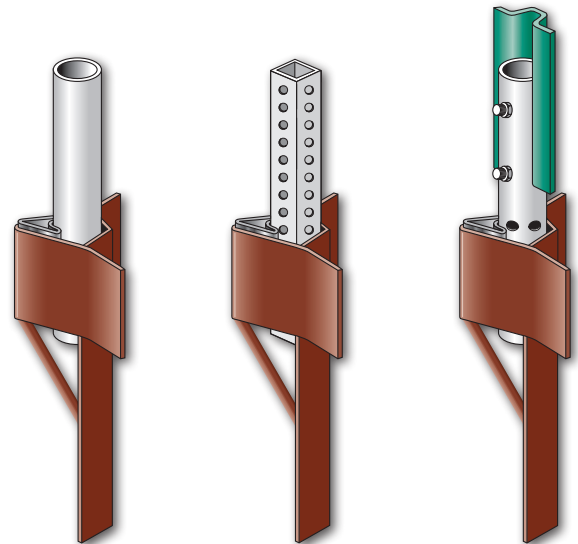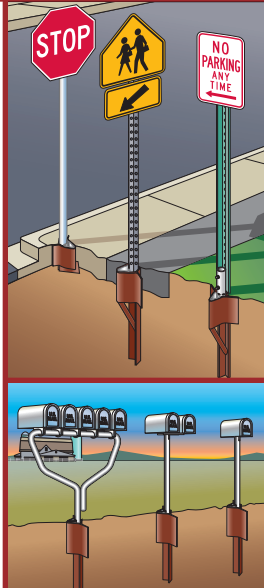

- **FLUSH MOUNT**
Helps prevent vehicle rollovers by eliminating above-ground extensions, reducing tort liability.
- **NCHRP 350 APPROVED**
Safety for drivers. Breakaway feature will allow product to breakaway from car as it's struck.
- **GUARANTEED REUSABILITY**
Saves the customer time and money as only the damaged post will need replacement.
- **STABILIZER BAR & BOLT**
Will keep the post stable in any weather condition. Anti-twist and turning.
- **YIELD AND RELEASE METHODS**
Allocates time for post to pop up which allows drivers to drive through.

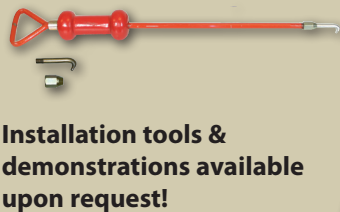

Installation tools & demonstrations available upon request!



Approvals

FHWA Accepted under SS-72 & B-13; AASHTO Recommended State Approvals Listing/Letters available upon request.
Patented Product!





V-Loc post
ANCHORS

NEW BREAKAWAY SIGN-POST REGULATIONS!

Now is the time to begin using "breakaway" supports for signs, to replace those that are non-conforming.

Here's Why: Breakaway Sign Supports are Required!

Rigid objects close to a roadway can become deadly hazards when struck by a vehicle that strays off the pavement. Supports for road signs frequently placed close to the roadway, are hazards if they are not designed, manufactured and constructed to break away upon impact. Even relatively small and innocent looking road sign supports can be deadly if they are not designed to break away. The Manual on Uniform Traffic Control Devices (MUTCD), which is the national standard used for all roads open to public travel, states in Section 2A-19: "... **Ground-mounted sign supports shall be breakaway, yielding or shielded with a longitudinal barrier or crash cushion if within the clear zone.**" This requirement applies to all roads, whether publicly or privately owned. Although state highway agencies are generally in compliance already, the Federal Highway Administration (FHWA) is concerned that many local agencies may not be aware of this requirement.

MUTCD: All non-breakaway sign supports shall be replaced by January 2013

The FHWA realizes that no agency can inventory, inspect, design, and replace non-breakaway sign supports overnight. The easiest way to accomplish this is to begin using breakaway supports when installing new signs or replacing damaged supports. All non-breakaway sign supports within the clear zone of roads posted at 50 mph or greater shall be replaced by January 2013. Thus you can save yourself time and money by using only compliant supports NOW for new installations, as well as when replacing existing, damaged sign post supports.

Which Sign Supports are Breakaway?

FHWA policy requires that all highway appurtenances, including sign supports, used on the National Highway System, meet performance criteria contained in the National Cooperative Highway Research Program (NCHRP) Report 350, Recommended Procedures for the Safety Performance Evaluation of Highway Features. All of TAPCO's V-Loc Sign Sockets for round, square and u-channel posts are NCHRP350-approved Breakaway Supports.

V-Loc sockets also mount flush to the ground, eliminating the chance of causing vehicle roll-overs and the risk of unwanted, costly liability.

Are V-Loc Sockets Reusable?

V-Loc Sockets are reusable after knockdowns. Simply put a new post in the socket and drive in a new wedge. Cut down on your replacement costs and exposure of your workforce to traffic.

What about Mailbox Supports?

All of TAPCO's V-Loc Sockets and Supports for Single, Double and Multiple Mailboxes are NCHRP350-approved Breakaway Supports. Several States have already specified them for their roadways. Contact TAPCO for additional information on V-Loc Supports. *Please contact TAPCO today to ensure that your sign and mailbox posts will conform to FHWA regulations.*

For more information on **safer sign supports**: http://safety.fhwa.dot/dog/roadway_dept/safersigns.htm

For more information on **V-Loc Sign and Mailbox Support Systems** visit: www.tapconet.com/vloc.html